

**EXISTING** 

100.5

---- 100 ----

———— 4"W ———

= = = 8"SD= = = =

----- CATV -----

——O C.O.

**⇔**++

**APPROX** 

BIT

BLK

BM

CMP

CONC

**EXIST** 

FDN

FF

FG

INV

IPF

MIN

PVMT

REQD

SAN

SS

SSE

STD

TBM

TYP

BLDG

**APPROXIMATE** 

BITUMINOUS

BENCHMARK

CONCRETE

EXISTING

INVERT

MINIMUM

PAVEMENT

REQUIRED

SANITARY

STANDARD

TYPICAL

TOP OF CURB

TRANSPORTATION

STORM DRAIN

SANITARY SEWER

SANITARY SEWER EASEMENT

TEMPORARY BENCHMARK

VIRGINIA DEPARTMENT OF

**FOUNDATION** 

FINISHED FLOOR

IRON PIN FOUND

FINISH GRADE

**BUILDING** 

BLOCK

BOTTOM OF CURB

CORRUGATED METAL PIPE

EDGE OF PAVEMENT

NEW 100.5

100

SPOT ELEVATION

SANITARY SEWER LINE

OVERHEAD ELECTRIC LINE

WATER OR GAS METER

OVERHEAD TELEPHONE LINE

OVERHEAD CABLE TELEVISION LINE

UNDERGROUND TEL OR ELEC LINE

DROP INLET (CURB OR GRATE)

UTILITY POLE, GUY & ANCHOR

SURVEY TRAVERSE POINT

CONTOURS

**WATERLINE** 

GAS LINE

**VALVE** 

MANHOLE


CLEANOUT


FIRE HYDRANT

PROPERTY LINE

BENCHMARK

STORM DRAIN

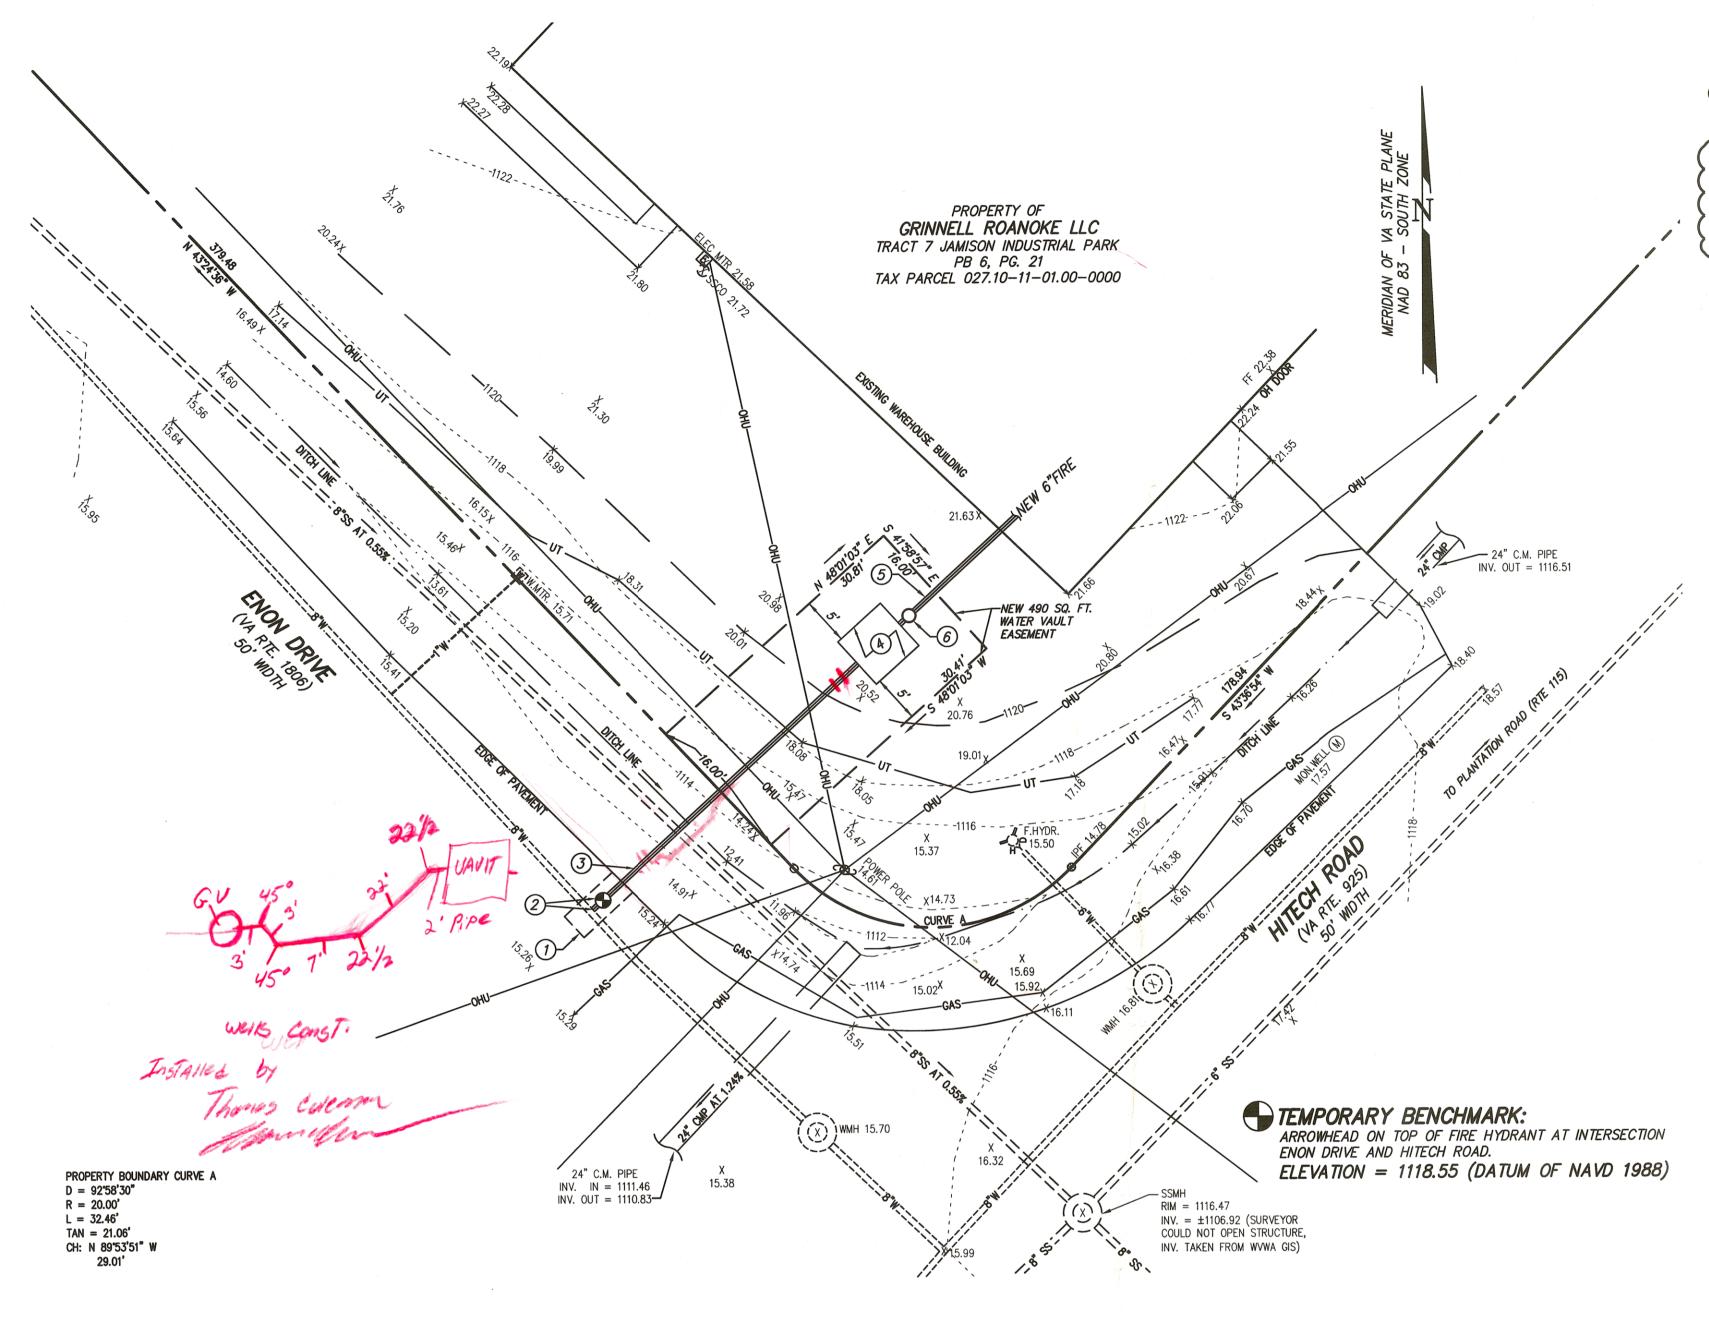

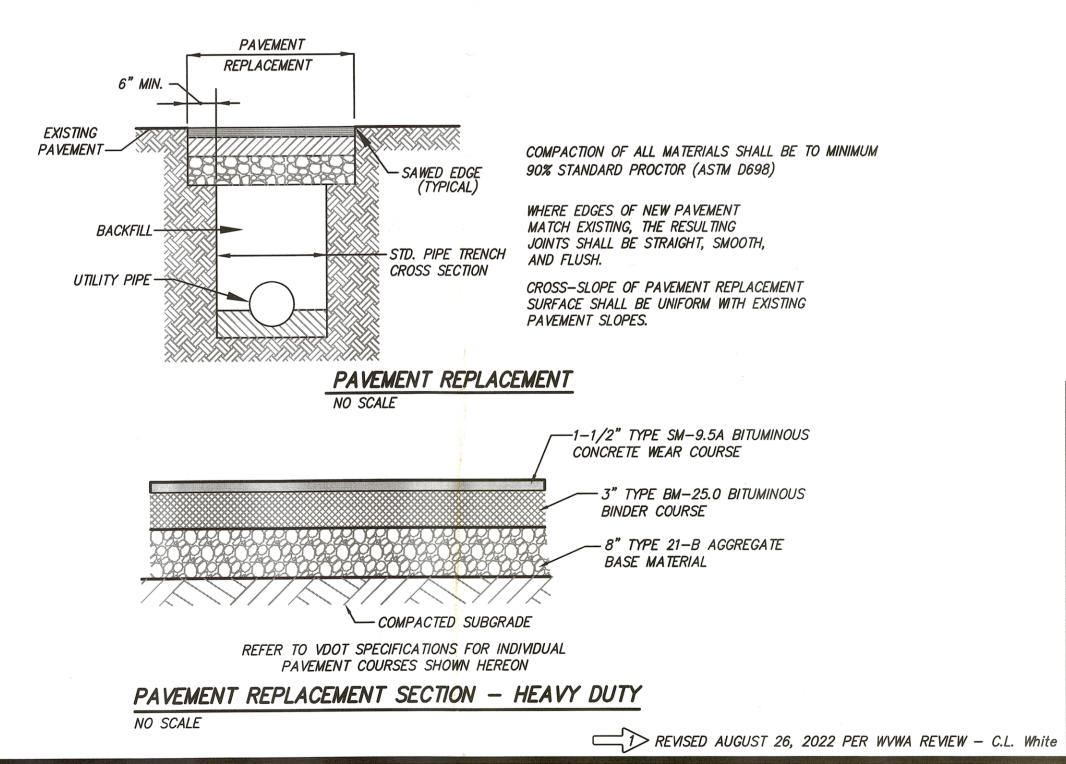

## KEY NOTES - NEW FIRE SERVICE

- 1. SAW-CUT EXISTING PAVEMENT FOR NEW INTERCONNECTION TO EXISTING WATER MAIN, SEE PAVEMENT REPLACEMENT DETAIL AND PAVEMENT REPLACEMENT SECTION FOR PAVEMENT REQUIREMENTS.
- (2.) PROVIDE A CUT-IN REDUCING TEE TO CONNECT NEW 6" FIRE LINE TO EXISTING 8" PUBLIC MAIN. CONTRACTOR SHALL PROVIDE ALL MATERIALS AND LABOR, WITH INSPECTIONS BY THE WVWA. INSTALL NEW 6" GATE VALVE AND TRAFFIC BEARING VALVE BOX. VALVE SHALL BE CONNECTED TO REDUCING TEE. COORDINATE INSPECTION REQUIREMENTS WITH THE WVWA.

REVISED FROM WET-TAP TO

CUT-IN TEE


- 3. PROVIDE NEW 6" PUBLIC WATERLINE BETWEEN NEW GATE VALVE AND NEW VAULT.
- 4. PROVIDE NEW 6'x6' TYPE 'W-7' FIRE VAULT, SEE DETAIL THIS SHEET. DISREGARD ALL REFERENCES TO DOMESTIC PIPE AND FITTINGS IN THE DETAIL, AS THE PROPOSED VAULT IS FOR FIRE SERVICE ONLY.
- (5.) PROVIDE NEW 6" PRIVATE WATERLINE FROM VAULT TO INTERCONNECT WITH NEW FIRE SUPPRESSION SYSTEM IN THE BUILDING.
- 6. PROVIDE NEW POST INDICATOR VALVE (PIV) ASSEMBLY.
  INTERCONNECT WITH FIRE SUPPRESSION PANEL AS REQUIRED BY
  SPRINKLER CONTRACTOR.

SEE SPRINKLER / SITE PLAN PREPARED BY VSC FIRE & SECRITY INC, FOR LOCATION OF NEW FIRE DEPARTMENT CONNECTION (FDC).

APPROVED

By Aaron Shearer at 2:41 pm, Aug 26, 2022

ALL NEW WATERLINE MATERIALS, FABRICATION, AND INSTALLATION SHALL BE IN ACCORDANCE WITH THE WESTERN VIRGINIA REGIONAL DESIGN AND CONSTRUCTION STANDARDS.

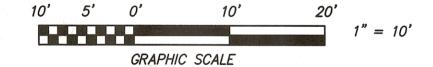

CORBIN L. WHITE License No. 23843

08-26-2022

Thomassional Engineers

## NEW FIRE SERVICE LATERAL AND VAULT FOR VSC FIRE & SECURITY INC.

TO BE CONSTRUCTED FOR NEW FIRE SUPPRESSION SYSTEM TRACT 7 JAMISON INDUSTRIAL PARK (P.B. 6, PG. 21)

SITUATE 7703 ENON DRIVE HOLLINS MAGISTERIAL DISTRICT COUNTY OF ROANOKE, VIRGINIA

Designed: C.L. White

Drawn: C.L. White

Checked: Date: August 16, 2022

Scale: 1" = 10'

Tax Parcel: 027.10-11-01.00-0000

Field Book: CH-27

W.O. No.: 22-0059

CALDWELL WHITE ASSOCIATES

4203 MELROSE AVENUE P.O. BOX 6260 ROANOKE, VIRGINIA 24017-0260 (540) 366-3400 FAX: (540) 366-8702

ENGINEERS / SURVEYORS / PLANNERS