TEMPORARY SEDIMENT TRAP DATA				(Ho)		(H)_	вотто	M DIMS.								
	DRAINAGE	DRY/WET ST	ORAGE (C.Y.)	WEIR	WEIR		BERM	TRAP	TRAP	TRAP	воттом	EXCAVATED	OUTLET		STONE	BERM
	AREA	REQ'D	DESIGN	LENGTH	HEIGHT	EMBANKMENT	HEIGHT	HTDIW	LENGTH	DEPTH	TRAP INV.	WET	STONE	DRY	CREST	EMBANK.
STRUCTURE (ST)	(ACRES)	WET/DRY	WET/DRY	(FT.)	(FT.)	WIDTH (FT.)	(FT.)	(FT.)	(FT.)	(FT.)	ELEV.	DEPTH	BASE ELEV.	DEPTH	ELEV.	ELEV.
Α	1.40	94/94	96/96	10	1.3	2.5	2.3	22	59	2.3	1184.0	2	1186.0	1.3	1187.3	1188.3

SUITABLE LOCA	ITIONS ARE TO B	E DETERMINED BY TH	HE CONTRACTOR. SIL	T FENCE SHALL BE PLACED	AROUND THE PERIMETER OF
THE STOCKPILE	. TEMPORARY SI	EEDING MEASURES A	PPLY TO STOCKPILES.	. STOCKPILE SHALL BE WITH	IN DELINEATED LIMITS OF
DISTURBANCE.					
■ THE CONTRACT	OR SHALL CHECK	AND VERIEV ALL EV	YISTING PERIMETED FO	POSION AND SEDIMENT CONTE	OF MEASURES ADDITION THE

• CONTRACTOR SHALL MAINTAIN THE CLEARED ACCESS ROAD AS NECESSARY FOR TRUCK TRAFFIC AND TO LIMIT EROSION/SEDIMENT DISCHARGE. CONSTRUCTION ROAD STABILIZATION (CRS) MAY BE USED AS NECESSARY. IF CONSTRUCTION ROAD STABILIZATION (CRS) IS UTILIZED IT SHALL BE REMOVED AT THE END OF THE PROJECT. AT THE END OF THE PROJECT THE CLEARED ACCESS

. TOPSOIL STOCKPILING IS ANTICIPATED FOR THIS PROJECT AND IS SHOWN. IF ADDITIONAL TOPSOIL AREAS ARE REQUIRED, THEN THE

BORROW AREA PHASE II EROSION AND SEDIMENT CONTROL MEASURES / CONSTRUCTION

CONSTRUCTION WILL BE SEQUENCED TO INSTALL INITIAL EROSION AND SEDIMENT CONTROL MEASURES PRIOR TO DEMOLITION. • CONTRACTOR SHALL VERIFY/INSTALL CONSTRUCTION ENTRANCE AS SHOWN ON PLANS. CONTRACTOR SHALL MAINTAIN THE

SEQUENCE:

CONSTRUCTION ENTRANCE PER VA ESCH STD. & SPEC 3.02.

PATH SHALL BE RETURNED TO EXISTING GRADE AND SEEDED.

AFTER THE INITIAL MEASURES ARE INSTALLED, THE CONTRACTOR MAY BEGIN GRADING.

 THE CONTRACTOR SHALL CHECK AND VERIFY ALL EXISTING PERIMETER EROSION AND SEDIMENT CONTROL MEASURES AROUND THE SITE. ANY PERIMETER EROSION CONTROL MEASURES THAT ARE DAMAGED SHALL BE REPAIRED TO CONTROL SEDIMENT LADEN RUNOFF FROM ENTERING ADJACENT PROPERTIES AND/OR STREAMS AND SWALES.

. ONCE THE SITE HAS BEEN STABILIZED, THE TEMPORARY EROSION AND SEDIMENT CONTROL MEASURES MAY BE REMOVED AND THOSE AREAS BROUGHT TO FINAL GRADE AND STABILIZED. THE CONTRACTOR SHALL COORDINATE WITH LOCAL AUTHORITY PRIOR TO REMOVING THE EROSION AND SEDIMENT CONTROL MEASURES. ALL MEASURES SHALL BE REMOVED WITHIN 30 DAYS AFTER FINAL SITE STABILIZATION OR AFTER TEMPORARY MEASURES ARE NO LONGER NEEDED, UNLESS OTHERWISE AUTHORIZED BY THE LOCAL PROGRAM AUTHORITY. ALL ESC MEASURES TO BE ALTERED OR REMOVED REQUIRE LOCAL AUTHORITY APPROVAL.

THE SILT FENCE AND CULVERT INLET PROTECTION SHALL BE REMOVED FROM THE PROJECT ONCE ALL DISTURBED AREAS ARE

		Job# Date: By:	17-0149:03 12-Jul-18 JPA	
ost Estii	nate	(Borrow	Area)	
	Unit	Unit Price	Price	
1	EA	\$1,200.00	\$1,200.0	
660	LF	\$4.00	\$2,640.0	
	LF	\$6.00	\$0.0	
	EA	\$150.00	\$0.0	
530	LF	\$5.00	\$2,650.0	
	LF	\$5.00	\$0.0	
1	EA	\$1,500.00	\$1,500.0	
	EA	\$100.00	\$0.0	
74000	SF	\$0.05	\$3,700.0	
74000	SF	\$0.04	\$2,960.0	
	SF	\$0.25	\$0.0	
	SF	\$0.35	\$0.0	
	EA	\$250.00	\$0.0	
	EA	\$5,000.00	\$0.0	
	EA	\$400.00	\$0.0	
	LF	\$10.00	\$0.0	
	LF	\$15.00	\$0.0	
	EA	\$150.00	\$0.0	
	CY	\$12.50	\$0.0	
	EA	\$1,500.00	\$0.0	
	EA	\$100.00	\$0.0	
	1 660 530 1 74000	Unit   EA   EA   EA   EA   EA   EA   EA   E	Date: By:    Date: By:	

## **GENERAL GRADING NOTES:**

1. THE CONTRACTOR SHALL REVIEW THE EROSION & SEDIMENT CONTROL NARRATIVE FOR PHASING OF EROSION & SEDIMENT CONTROL MEASURES. THE CONTRACTOR SHALL COMPLY WITH LOCAL CODES IN OBSERVING EROSION CONTROL MEASURES BOTH ON AND OFF THE SITE. REFER TO THE VIRGINIA EROSION AND SEDIMENT CONTROL HANDBOOK FOR DETAILS AND SPECIFICATIONS OF THOSE EROSION CONTROL ITEMS FOUND ON THESE DRAWINGS.

Total \$14,650.00

10% Contingency \$1,465.00


Total ESC Surety Amount \$16,115.00

- 2. THE CONTRACTOR SHALL PROVIDE ALL GRADING, GENERAL EXCAVATION, AND FINISH GRADING AS INDICATED ON THE DRAWINGS. WORK SHALL BE ACCOMPLISHED IN ACCORDANCE WITH VDOT STANDARDS AND SPECIFICATIONS. THE CONTRACTOR SHALL PROVIDE POSITIVE DRAINAGE AT ALL TIMES.
- 3. A DEQ VSMP PERMIT IS REQUIRED FOR THIS PROJECT. A COPY OF THE DEQ PERMIT, STORMWATER POLLUTION PREVENTION PLAN, AND MAINTENANCE LOGS SHALL BE KEPT ON SITE AND AVAILABLE FOR REVIEW AS REQUESTED.
- ALL EARTH SLOPES AND DENUDED AREAS SHALL BE SEEDED AND MULCHED AS REQUIRED FOR STABILIZATION. PERMANENT OR TEMPORARY SOIL STABILIZATION SHALL BE APPLIED TO DENUDED AREAS WITHIN SEVEN DAYS AFTER FINAL GRADE IS REACHED ON ANY PORTION OF THE SITE. TEMPORARY SOIL STABILIZATION SHALL BE APPLIED WITHIN SEVEN DAYS TO DENUDED AREAS THAT MAY NOT BE AT FINAL GRADE BUT WILL REMAIN DORMANT FOR LONGER THAN 14 DAYS. PERMANENT STABILIZATION SHALL BE APPLIED TO AREAS THAT ARE TO BE LEFT DORMANT FOR MORE THAN ONE YEAR.

## **EROSION AND SEDIMENT CONTROL MEASURES:**

PROVIDE THE FOLLOWING:

- (CE) CONSTRUCTION ENTRANCE MEETING VA ESCH STD. & SPEC. 3.02
- (SF) SILT FENCE MEETING VA ESCH STD. & SPEC. 3.05
- (DD) DIVERSION DIKE MEETING VA ESCH STD. & SPEC. 3.09
- (TS) SEDIMENT TRAP MEETING VA ESCH STD. & SPEC. 3.13
- TO) TOPSOILING MEETING VA ESCH STD. & SPEC. 3.30
- (TS) TEMPORARY SEEDING MEETING VA ESCH STD. & SPEC. 3.31
- (PS) PERMANENT SEEDING MEETING VA ESCH STD. & SPEC. 3.32
- (MU) MULCHING MEETING VA ESCH STD. & SPEC. 3.35
- (B/M) SOIL STABILIZING BLANKETS MEETING VA ESCH STD. & SPEC. 3.36
- (DC) DUST CONTROL MEETING VA ESCH STD. & SPEC. 3.39

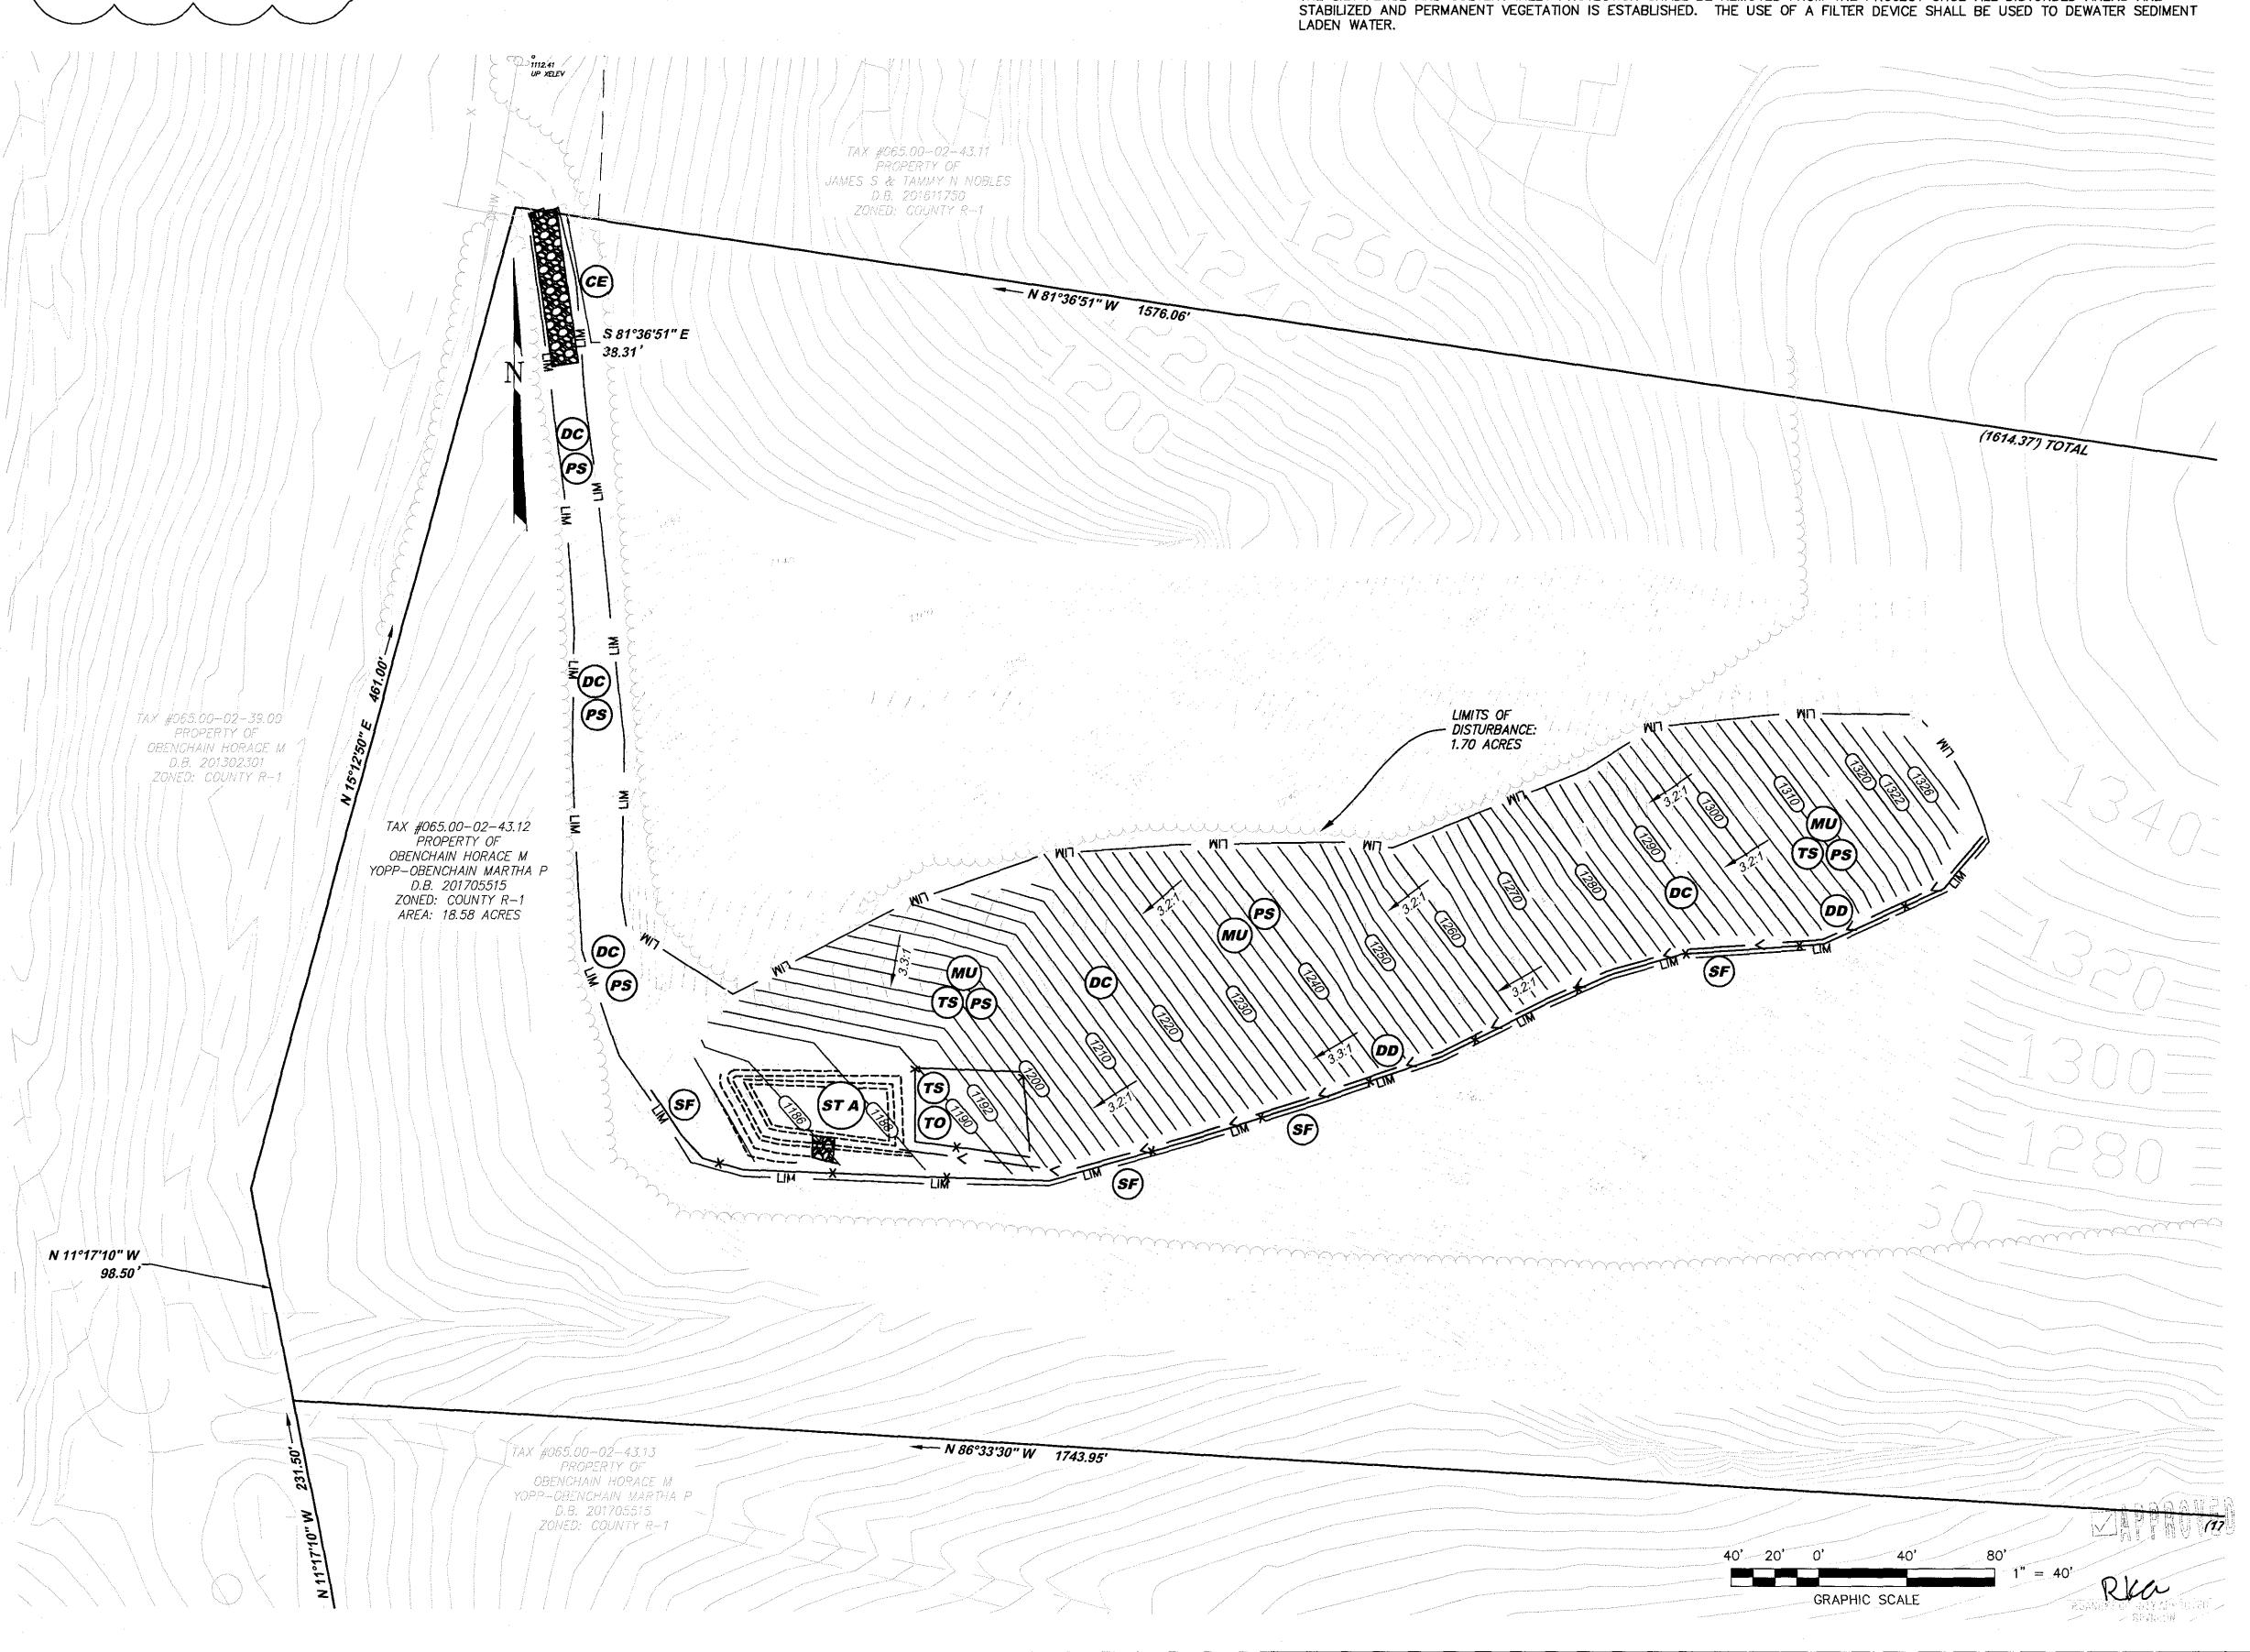

DESIGN GROUP

2122 Carolina Ave, SW Roanoke, VA 24014 Ph: 540-387-1153 Fax: 540-389-5767 1915-B W. Cary Street Richmond, VA 23220 Phone: 804-358-2947 Fax: 804-359-9645

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REVISIONS:

**DESIGNED BY: JLK** 

DRAWN BY: JLK CHECKED BY: SLR

> DATE: 11 December 2017 SHEET TITLE:

BORROW SITE GRADING & ESC

> 1" = 40'SHEET NO.