

S.S.M.H.
RIM=1266.99'
IN (8" PVC)=1260.49'
OUT (8" PVC)=1260.39'

LIMITS OF
DISTURBANCE
2.75

3.02
24' WIDE x
70' LONG
CE

PHASE 1 DESCRIPTION:
1. MAINTAIN ALL EROSION CONTROL MEASURES FROM
PREVIOUS GRADING PERMIT OWNERSHIP.

General Erosion and Sediment Control Notes,
Botetourt County, Va.

- ES-1: Unless otherwise indicated, all vegetative and structural erosion and sediment control practices will be constructed and maintained according to minimum standards and specifications of the Virginia Erosion and Sediment Control Handbook, latest edition, and Virginia Regulations VR 225-02-00 Erosion and Sediment Control Regulations.
- ES-2: The plan approving authority must be notified one week prior to the onsite preconstruction conference, one week prior to the commencement of land disturbing activity, and one week prior to the final inspection.
- ES-3: All erosion and sediment control measures are to be placed prior to or as the first step in clearing.
- ES-4: A copy of the approved erosion and sediment control plan & narrative, as well as a copy of the Land Disturbing Permit, shall be maintained on the site at all times. The Erosion and Sediment Control Administrator will deliver these materials at the onsite preconstruction conference.
- ES-5: Prior to commencing land disturbing activities in areas other than indicated on these plans (including, but not limited to, off-site borrow or waste areas), the contractor shall submit a supplementary erosion control plan to the owner for review and approval by the plan approving authority.
- ES-6: The contractor is responsible for installation of any additional erosion control measures necessary to prevent erosion and sedimentation as determined by the plan approving authority.
- ES-7: All disturbed areas are to drain to approved sediment control measures at all times during the land disturbing activities and during site development until final stabilization is achieved.
- ES-8: During dewatering operations, water will be pumped into an approved filtering device.
- ES-9: The contractor shall inspect all erosion control measures periodically and after each rainfall-producing rainfall event. Any necessary repairs or cleanup to maintain the effectiveness of the erosion control devices shall be made immediately. An inspection report must be filed with the Botetourt County Erosion & Sediment Control Administrator once every two weeks, beginning with commencement of the land disturbing activity, and within 48 hours of any runoff-producing rainfall event. Failure to submit a report will be grounds for immediate revocation of the Land Disturbing Permit. Reports must be submitted within 24 hours of the deadline. A standard inspection report form will be supplied, which should be copied as necessary. This provision in no way relieves the right of Botetourt County personnel to conduct site inspections, nor does it deny the right of the permittee(s) to accompany the inspector(s).
- to be included on all plans submitted for E&S approval; replace any other language on plans and in narrative which conflicts with these requirements

LE&D
PROFESSIONALS, P.C.



RIVER RUN EXECUTIVE OFFICES
SUITE-B
110 EXCHANGE STREET
DANVILLE, VA 24541

N.C. LICENSE: # C-2577
VA. LICENSE: # 0404-001401

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**PROPOSED SHEETZ STORE
SHEEYZ INC**
DALEVILLE-BOTETOURT COUNTY, VIRGINIA

E & S PHASE I

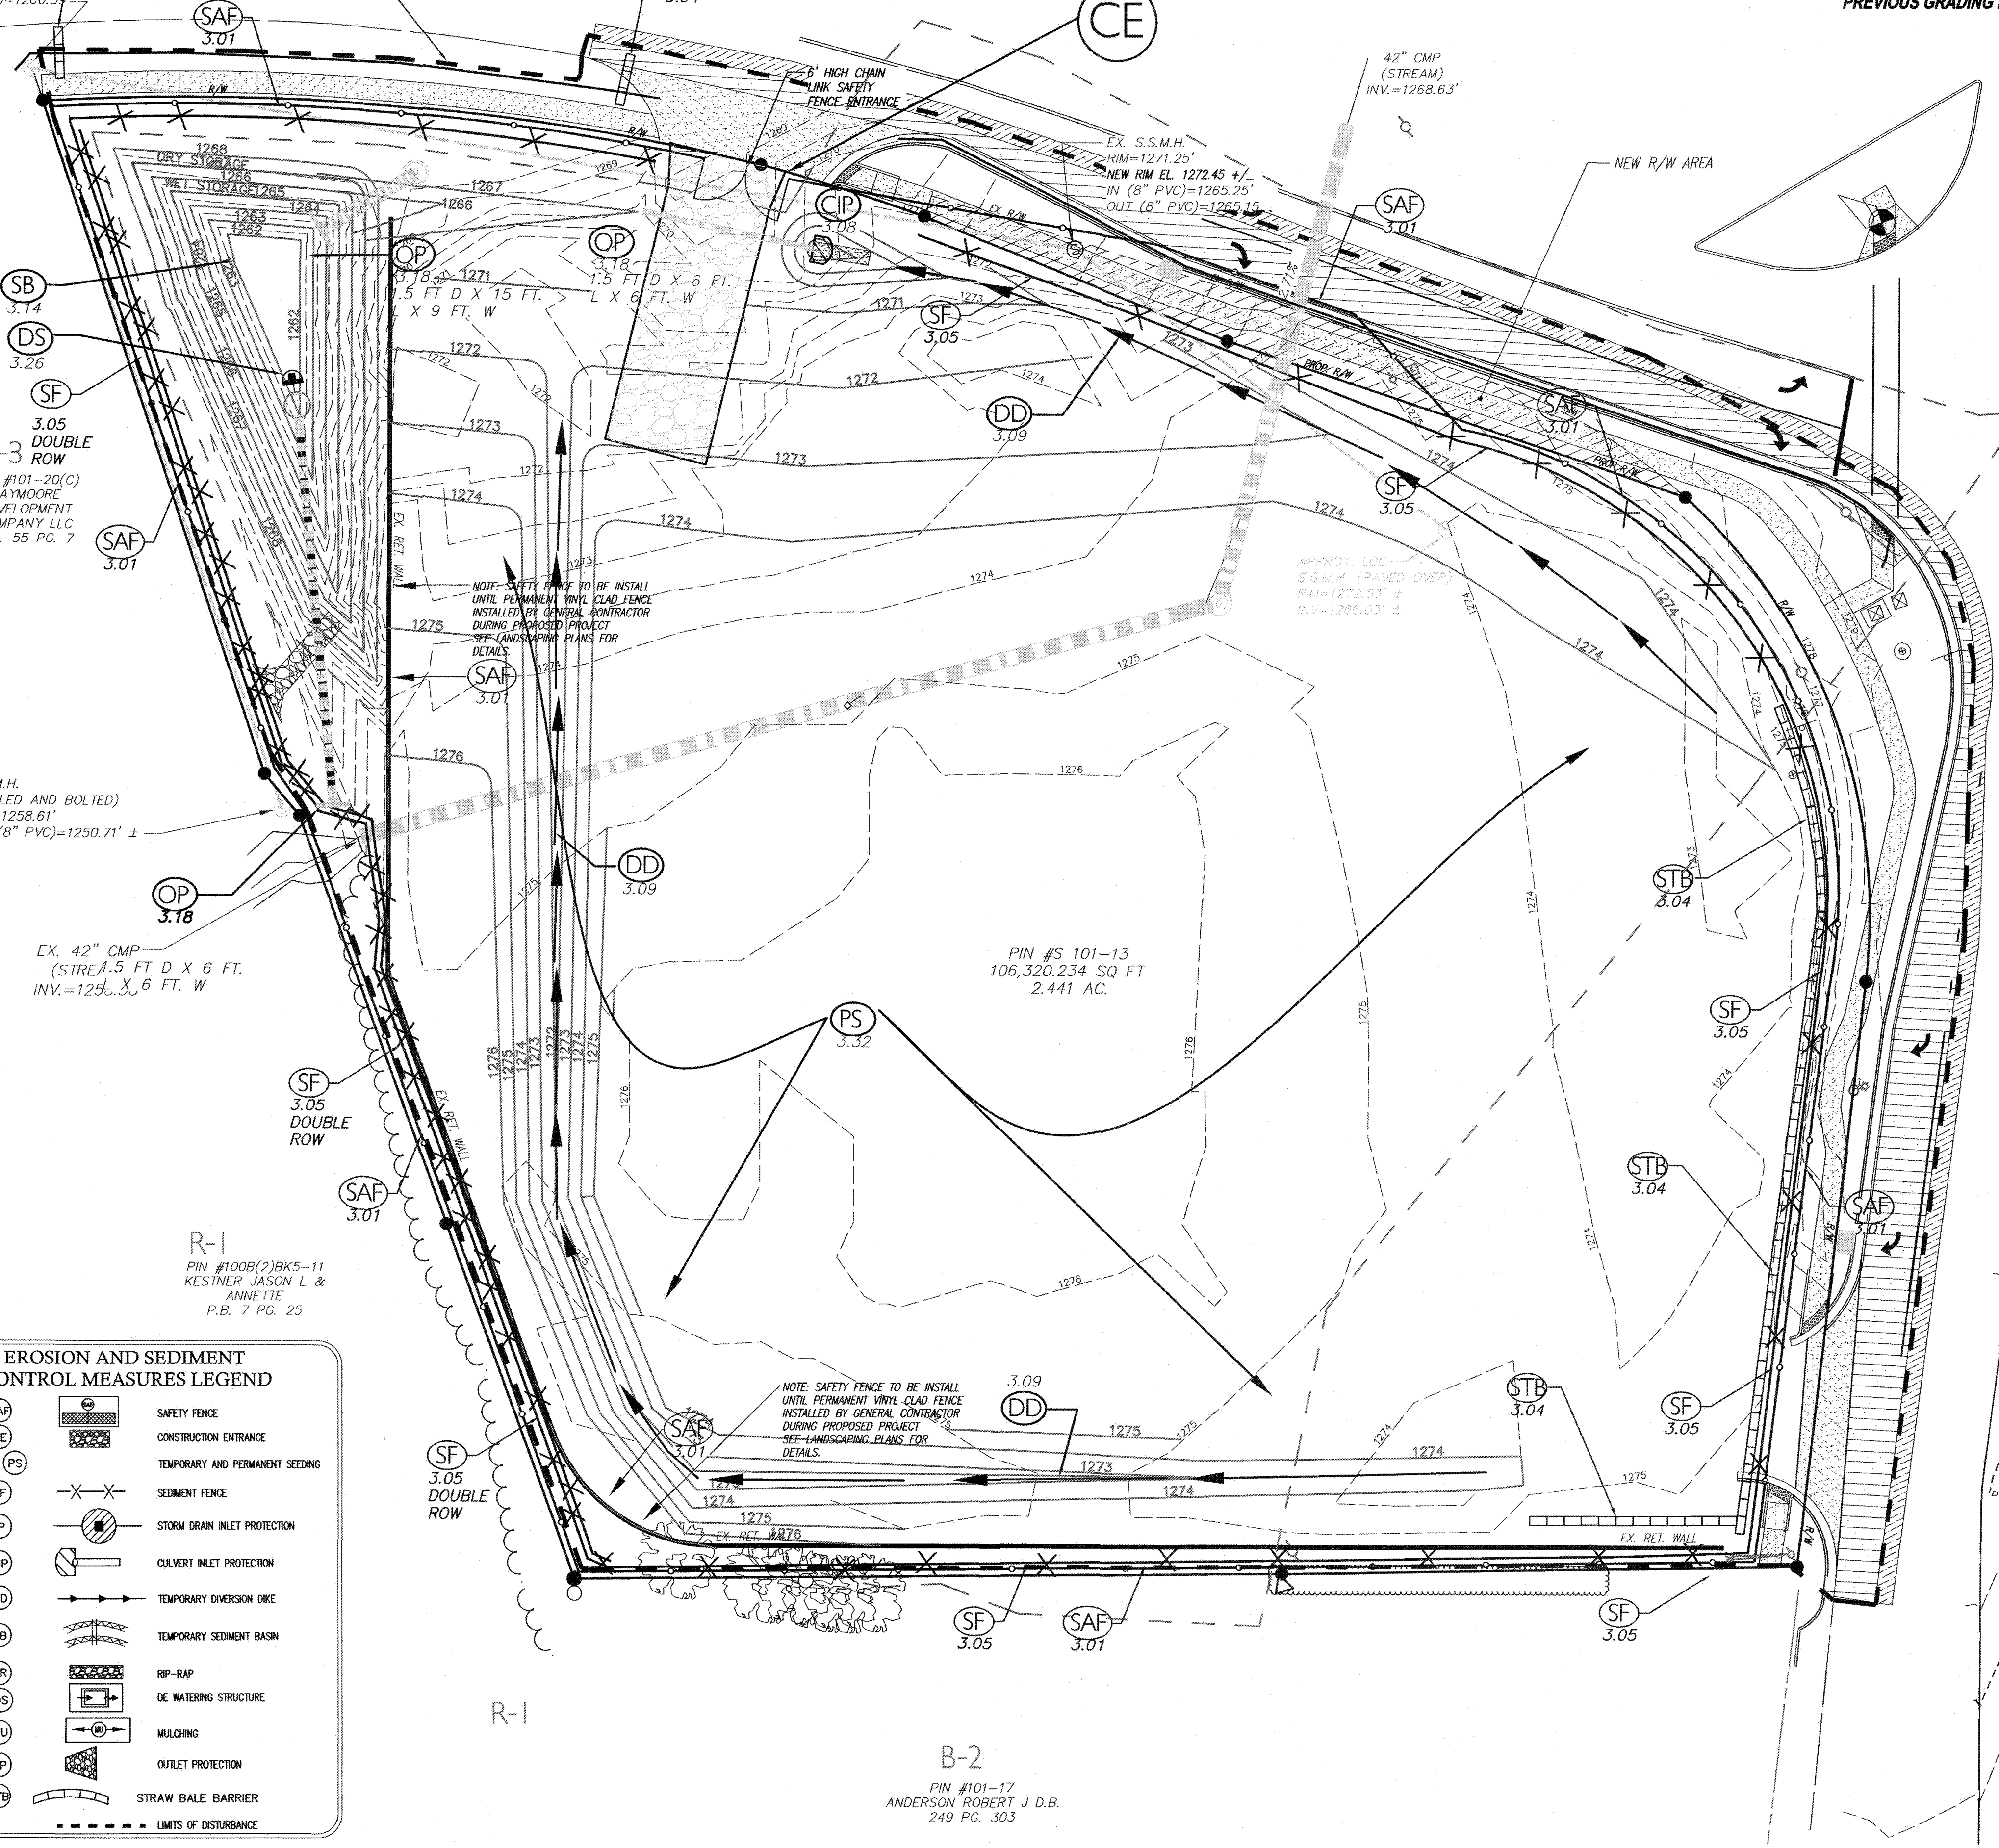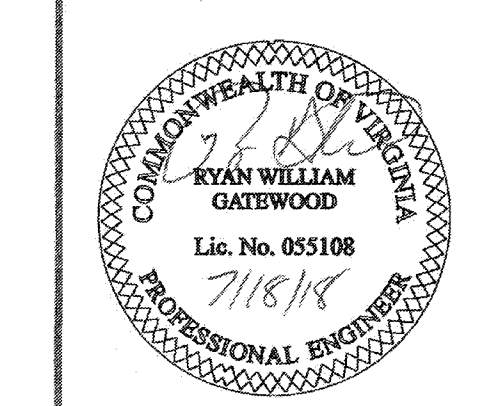

EROSION AND SEDIMENT CONTROL MEASURES LEGEND			
3.01	SAF		SAFETY FENCE
3.02	CE		CONSTRUCTION ENTRANCE
3.31/3.32	TS PS		TEMPORARY AND PERMANENT SEEDING
3.05	SF		SEDIMENT FENCE
3.07	IP		STORM DRAIN INLET PROTECTION
3.08	CIP		CULVERT INLET PROTECTION
3.09	DD		TEMPORARY DIVERSION DIKE
3.14	SB		TEMPORARY SEDIMENT BASIN
3.19	RR		RR-RAP
3.26	DS		DE WATERING STRUCTURE
3.35	MU		MULCHING
3.18	OP		OUTLET PROTECTION
3.04	STB		STRAW BALE BARRIER
- - - - - LIMITS OF DISTURBANCE			

- LEGEND:**
- EXISTING IRON
 - NEW IRON PIN/PAK NAIL
 - ▲ COMPUTED POINT
 - ⊙ EX R/W DISK
 - R/W-RIGHT OF WAY
 - OHE-OVERHEAD ELECTRIC
 - PIN: TAX PARCEL ID. NO.
 - SIGN
 - BOLLARD
 - MAIL BOX
 - TELEPHONE PEDESTAL
 - ELECTRIC TRANSFORMER
 - CABLE TELEVISION
 - ⊗ ELECTRIC METER
 - LIGHT POLE
 - ⊙ WITNESS POST
 - UTILITY POLE
 - GUY POLE
 - WATER VALVE
 - GAS STORAGE VALVE
 - WATER METER
 - FIRE HYDRANT
 - FIBER OPTICS
 - ORNAMENTAL TREE OR SHRUB
 - SANITARY SEWER CLEAN-OUT
 - SANITARY SEWER MANHOLE
 - STORM DRAIN INLET STRUCTURE (116)
 - ⊕ TANK FILL COVERS
 - STORM DRAIN MANHOLE
 - ⊙ AIR CONDITIONER UNIT
 - WELL
 - UT— UNDERGROUND TELEPHONE LINE
 - W— WATER LINE
 - UE— UNDERGROUND ELECTRIC LINE
 - GAS— GAS LINE
 - X— WOVEN WIRE FENCE LINE
 - OHU— OVERHEAD UTILITY LINES
 - OHE— OVERHEAD ELECTRIC LINES
 - SAN— SANITARY SEWER LINE
 - ○— CHAIN LINK FENCE
 - --- UNDERGROUND FIBER OPTIC LINE
 - M.B.L.— MINIMUM BUILDING LINE
 - INST#— INSTRUMENT NUMBER

B-2
PIN #101-17
ANDERSON ROBERT J D.B.
249 PG. 303

REVISIONS		NO.	DATE	DESCRIPTION
BY	DATE			
1	7-18-18	1		
2				
3				
4				
5				
6				
7				
8				
9				
10				

Sheet No. **7** of **25**

Date: MAY 4, 2018
Scale: 1" = 20'
Project No. **MPG-SQW17-ENG-001-F-SQW17-PLAN-1-REV-1**