


Denotes locations (4 total) of anchorage for prestressed concrete voided slab beams. See Sheet B-12 for details.

FRAMING PLAN
Scale: 1/8" = 1'-0"

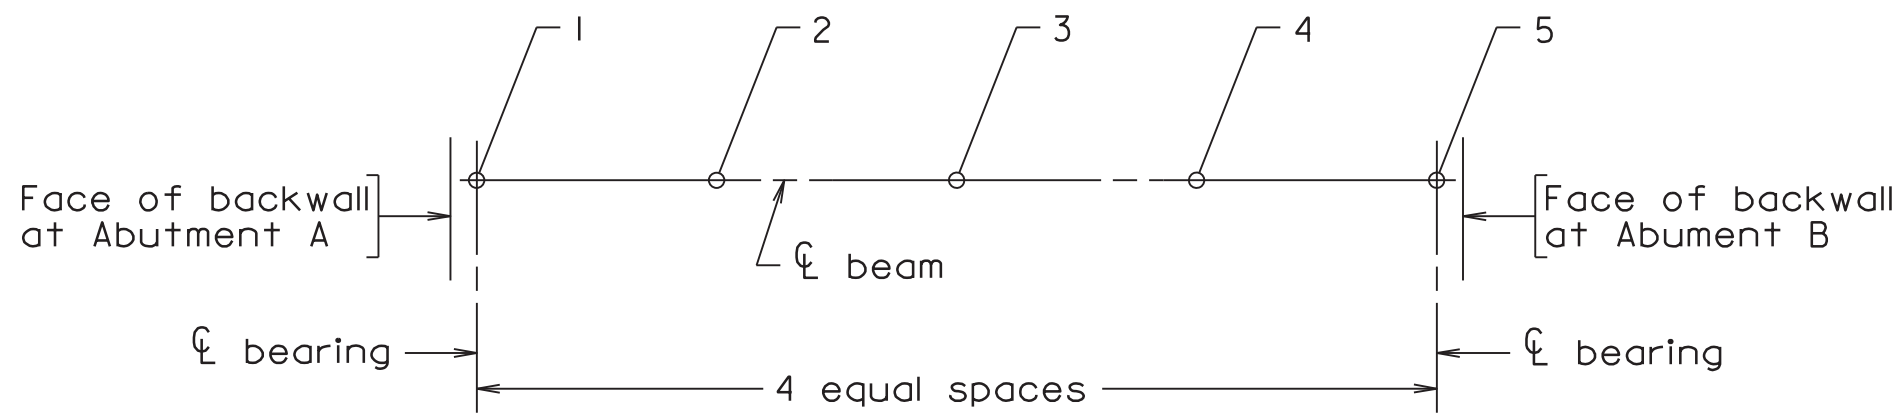

PLAN

Showing points of top of slab elevations

TOP OF SLAB ELEVATIONS ALONG CL BEAMS					
Point	1	2	3	4	5
Beam 1	938.29	937.89	937.50	937.11	936.71
Beam 2	937.87	937.47	937.08	936.99	936.29
Beam 3	937.44	937.05	936.66	936.26	935.87
Beam 4	937.02	936.63	936.24	935.84	935.45
Beam 5	936.60	936.21	935.81	935.42	935.03
Beam 6	936.18	935.79	935.39	935.00	934.61
Beam 7	935.76	935.36	934.97	934.58	934.18
Beam 8	935.34	934.94	934.55	934.16	933.76

Notes:

- For prestressed concrete voided slab beam details, see Sheet B-12.

COMMONWEALTH OF VIRGINIA

03/10/2017

CHAD M. THOMAS

Lic. No. 036692

PROFESSIONAL ENGINEER

Issue

Date

Revisions

Issue Date:

03/10/17

Drawn By:

DKA

Designed By:

MLF

Checked By:

CMT

Date:

03/10/17

MM

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City of Roanoke

Planning, Building, & Development

COMPREHENSIVE DEVELOPMENT PLAN

APPROVED

by Adrian Gilbert 03/15/2018

BERKLEY ROAD OVER GLADE CREEK TRIBUTARY A

FRAMING PLAN AND

TOP OF SLAB ELEVATIONS

CITY OF ROANOKE, VA

Vertical Scale:

N/A

Horizontal Scale:

AS NOTED

Commission Number:

34301

Sheet No.:

B-11