

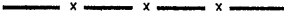


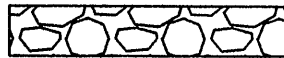


















EROSION CONTROL LEGEND


| REF. | <u>VESCH STD. AND SPEC.</u> |
|---|--|
|  | 3.02  CONSTRUCTION ENTRANCE |
|  | 3.05  SILT FENCE |
|  | 3.07  STORM DRAIN INLET PROTECTION |
|  | 3.08  CULVERT INLET PROTECTION |
|  | 3.09  TEMPORARY DIVERSION DIKE |
|  | 3.11  TEMPORARY RIGHT-OF-WAY DIVERSION |
| | 3.13  TEMPORARY SEDIMENT TRAP |
|  | 3.18  OUTLET PROTECTION (ALL OP SHOWN IS 6' x 6') |
|  | 3.19  RIPRAP |
| | 3.31  TEMPORARY SEEDING |
| | 3.32  PERMANENT SEEDING |
| | 3.33  SODDING |
|  | LIMITS OF DISTURBANCE |
|  | UTILITIES TO BE REMOVED |

DEMOLITION & EARTHWORK NOTES


DEMOLITION PERMIT WILL BE REQUIRED BY THE COUNTY OF ROANOKE PRIOR TO DEMOLITION OF THE EXISTING STRUCTURES

ALL MATERIAL REMOVED FROM THE SITE MUST GO TO A PERMITTED DISPOSAL SITE.


ROANOKE COUNTY IS TO BE CONTACTED AT THE TIME OF THE INSTALLATION OF THE STORM SEWER, THE RAIN TANK, AND THE STORM FILTER UNIT.

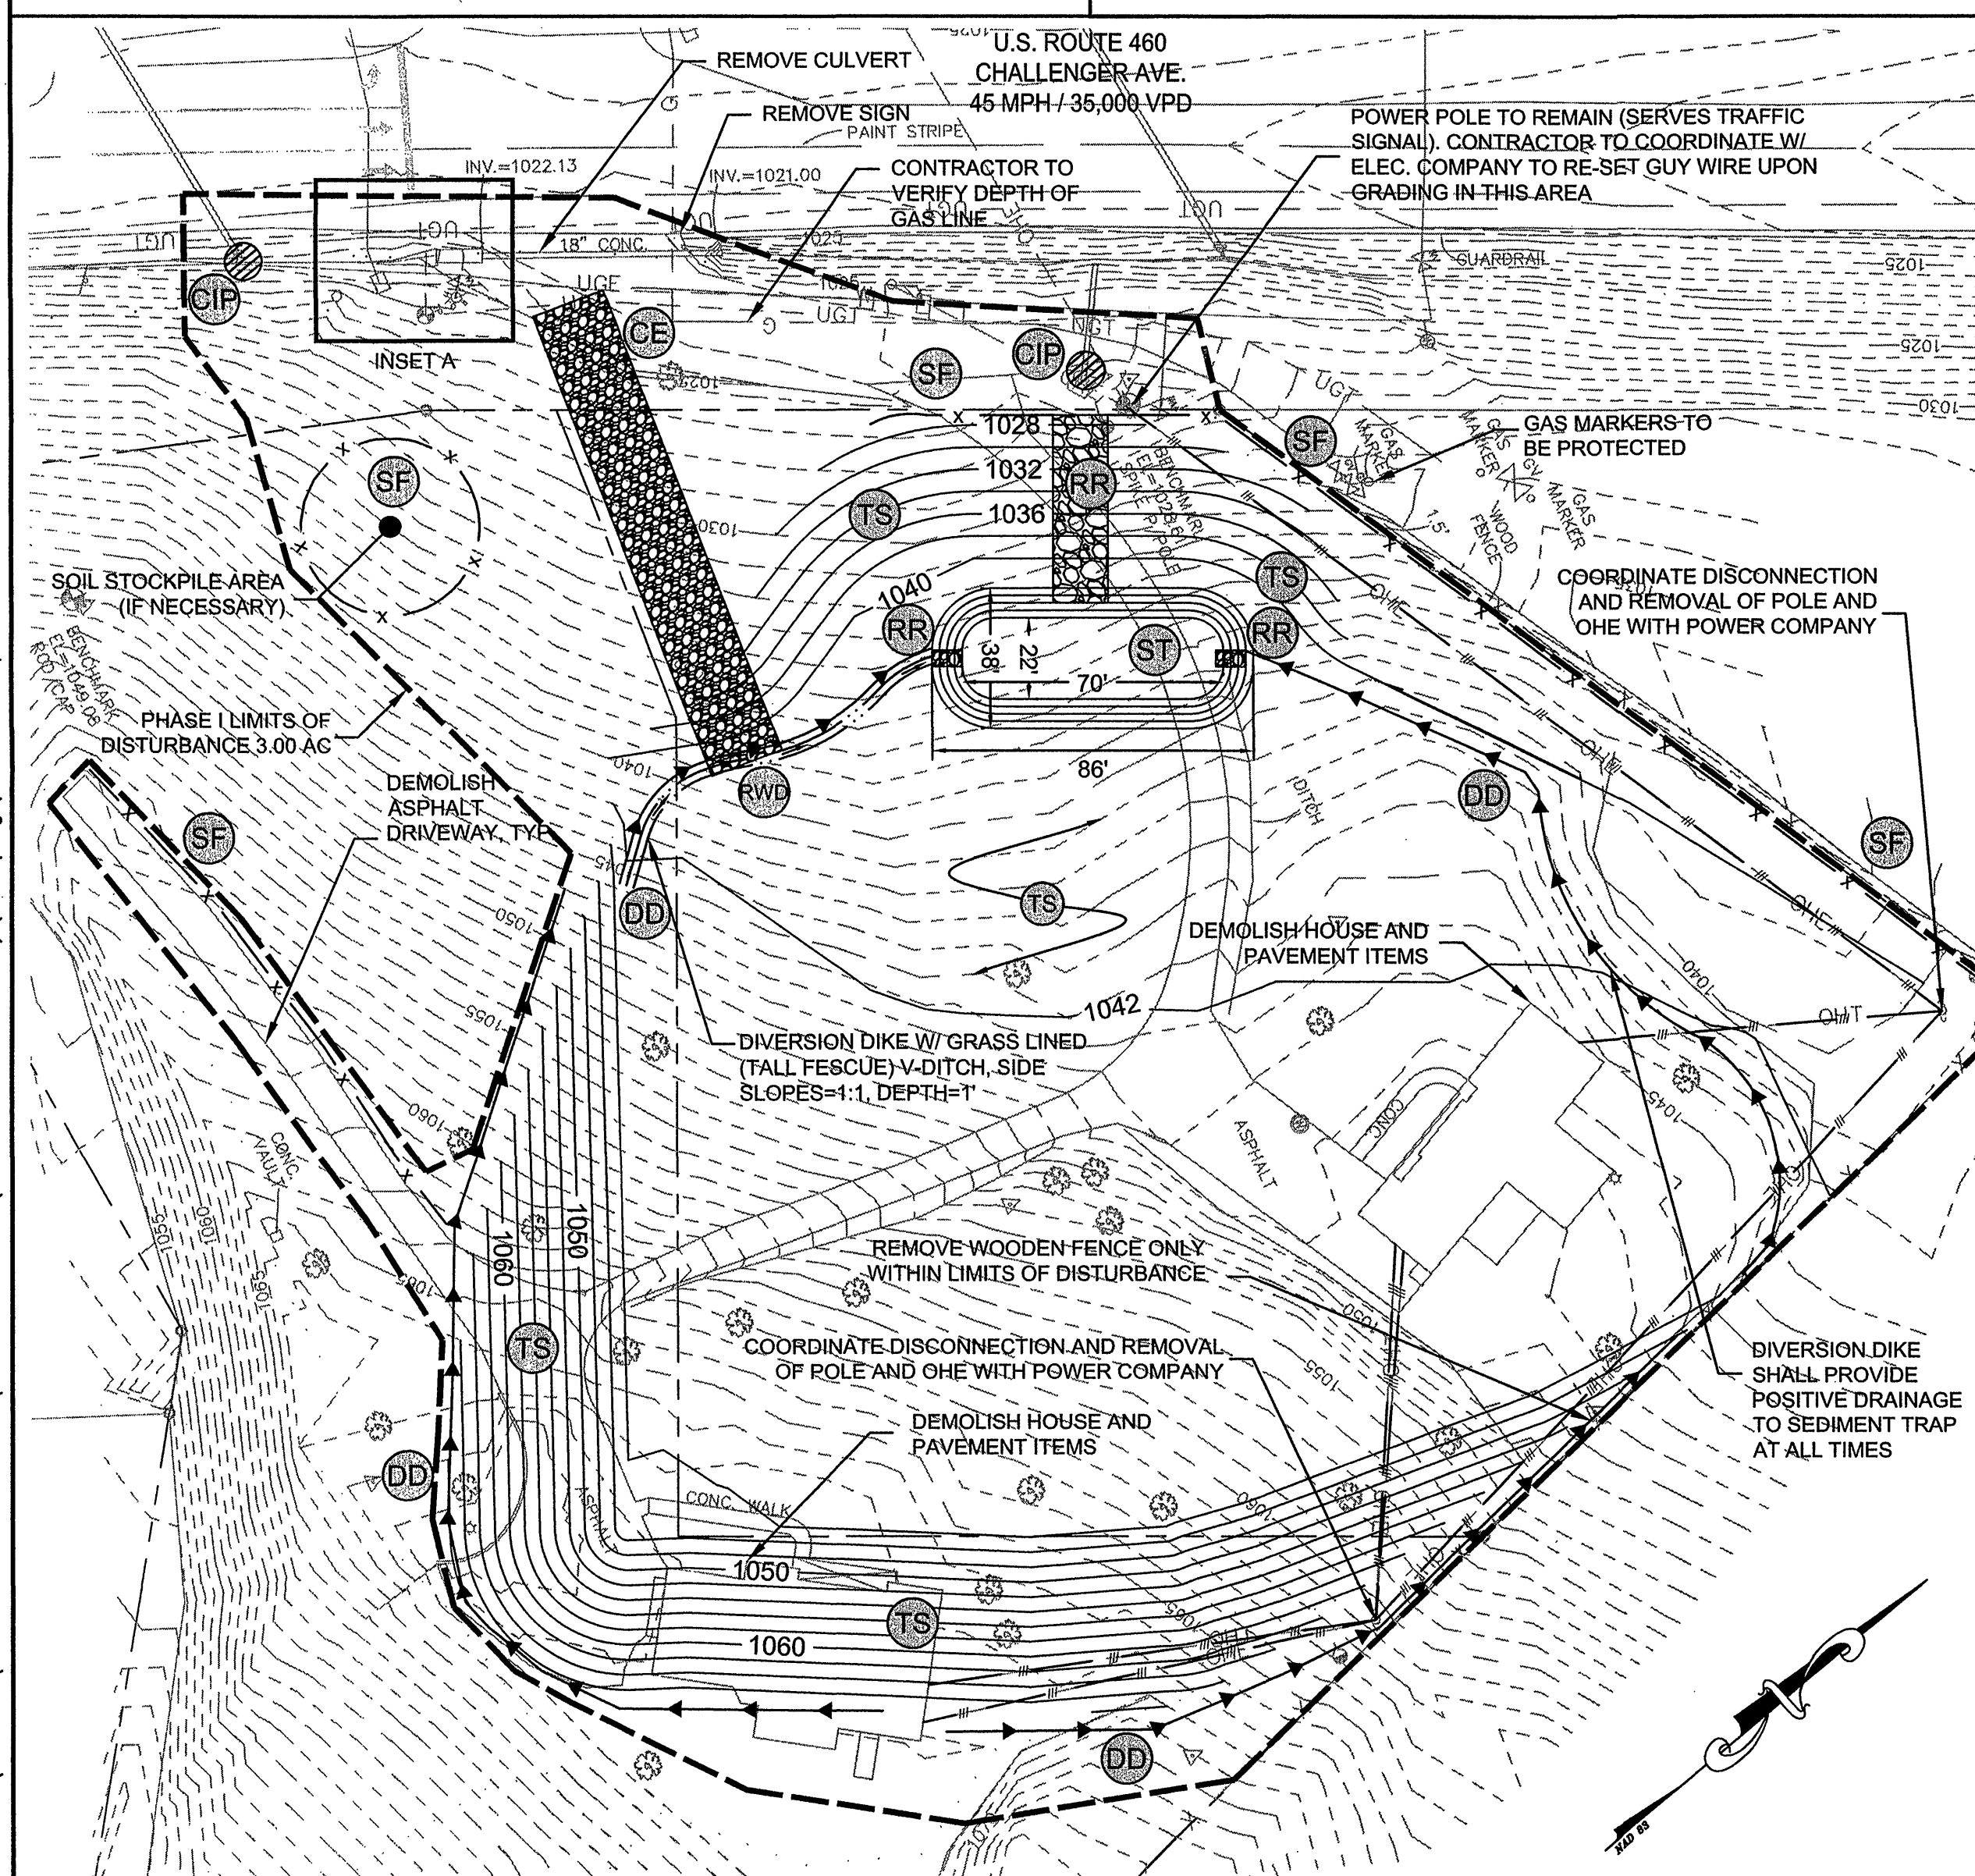

PHASE I EROSION CONTROL PLAN

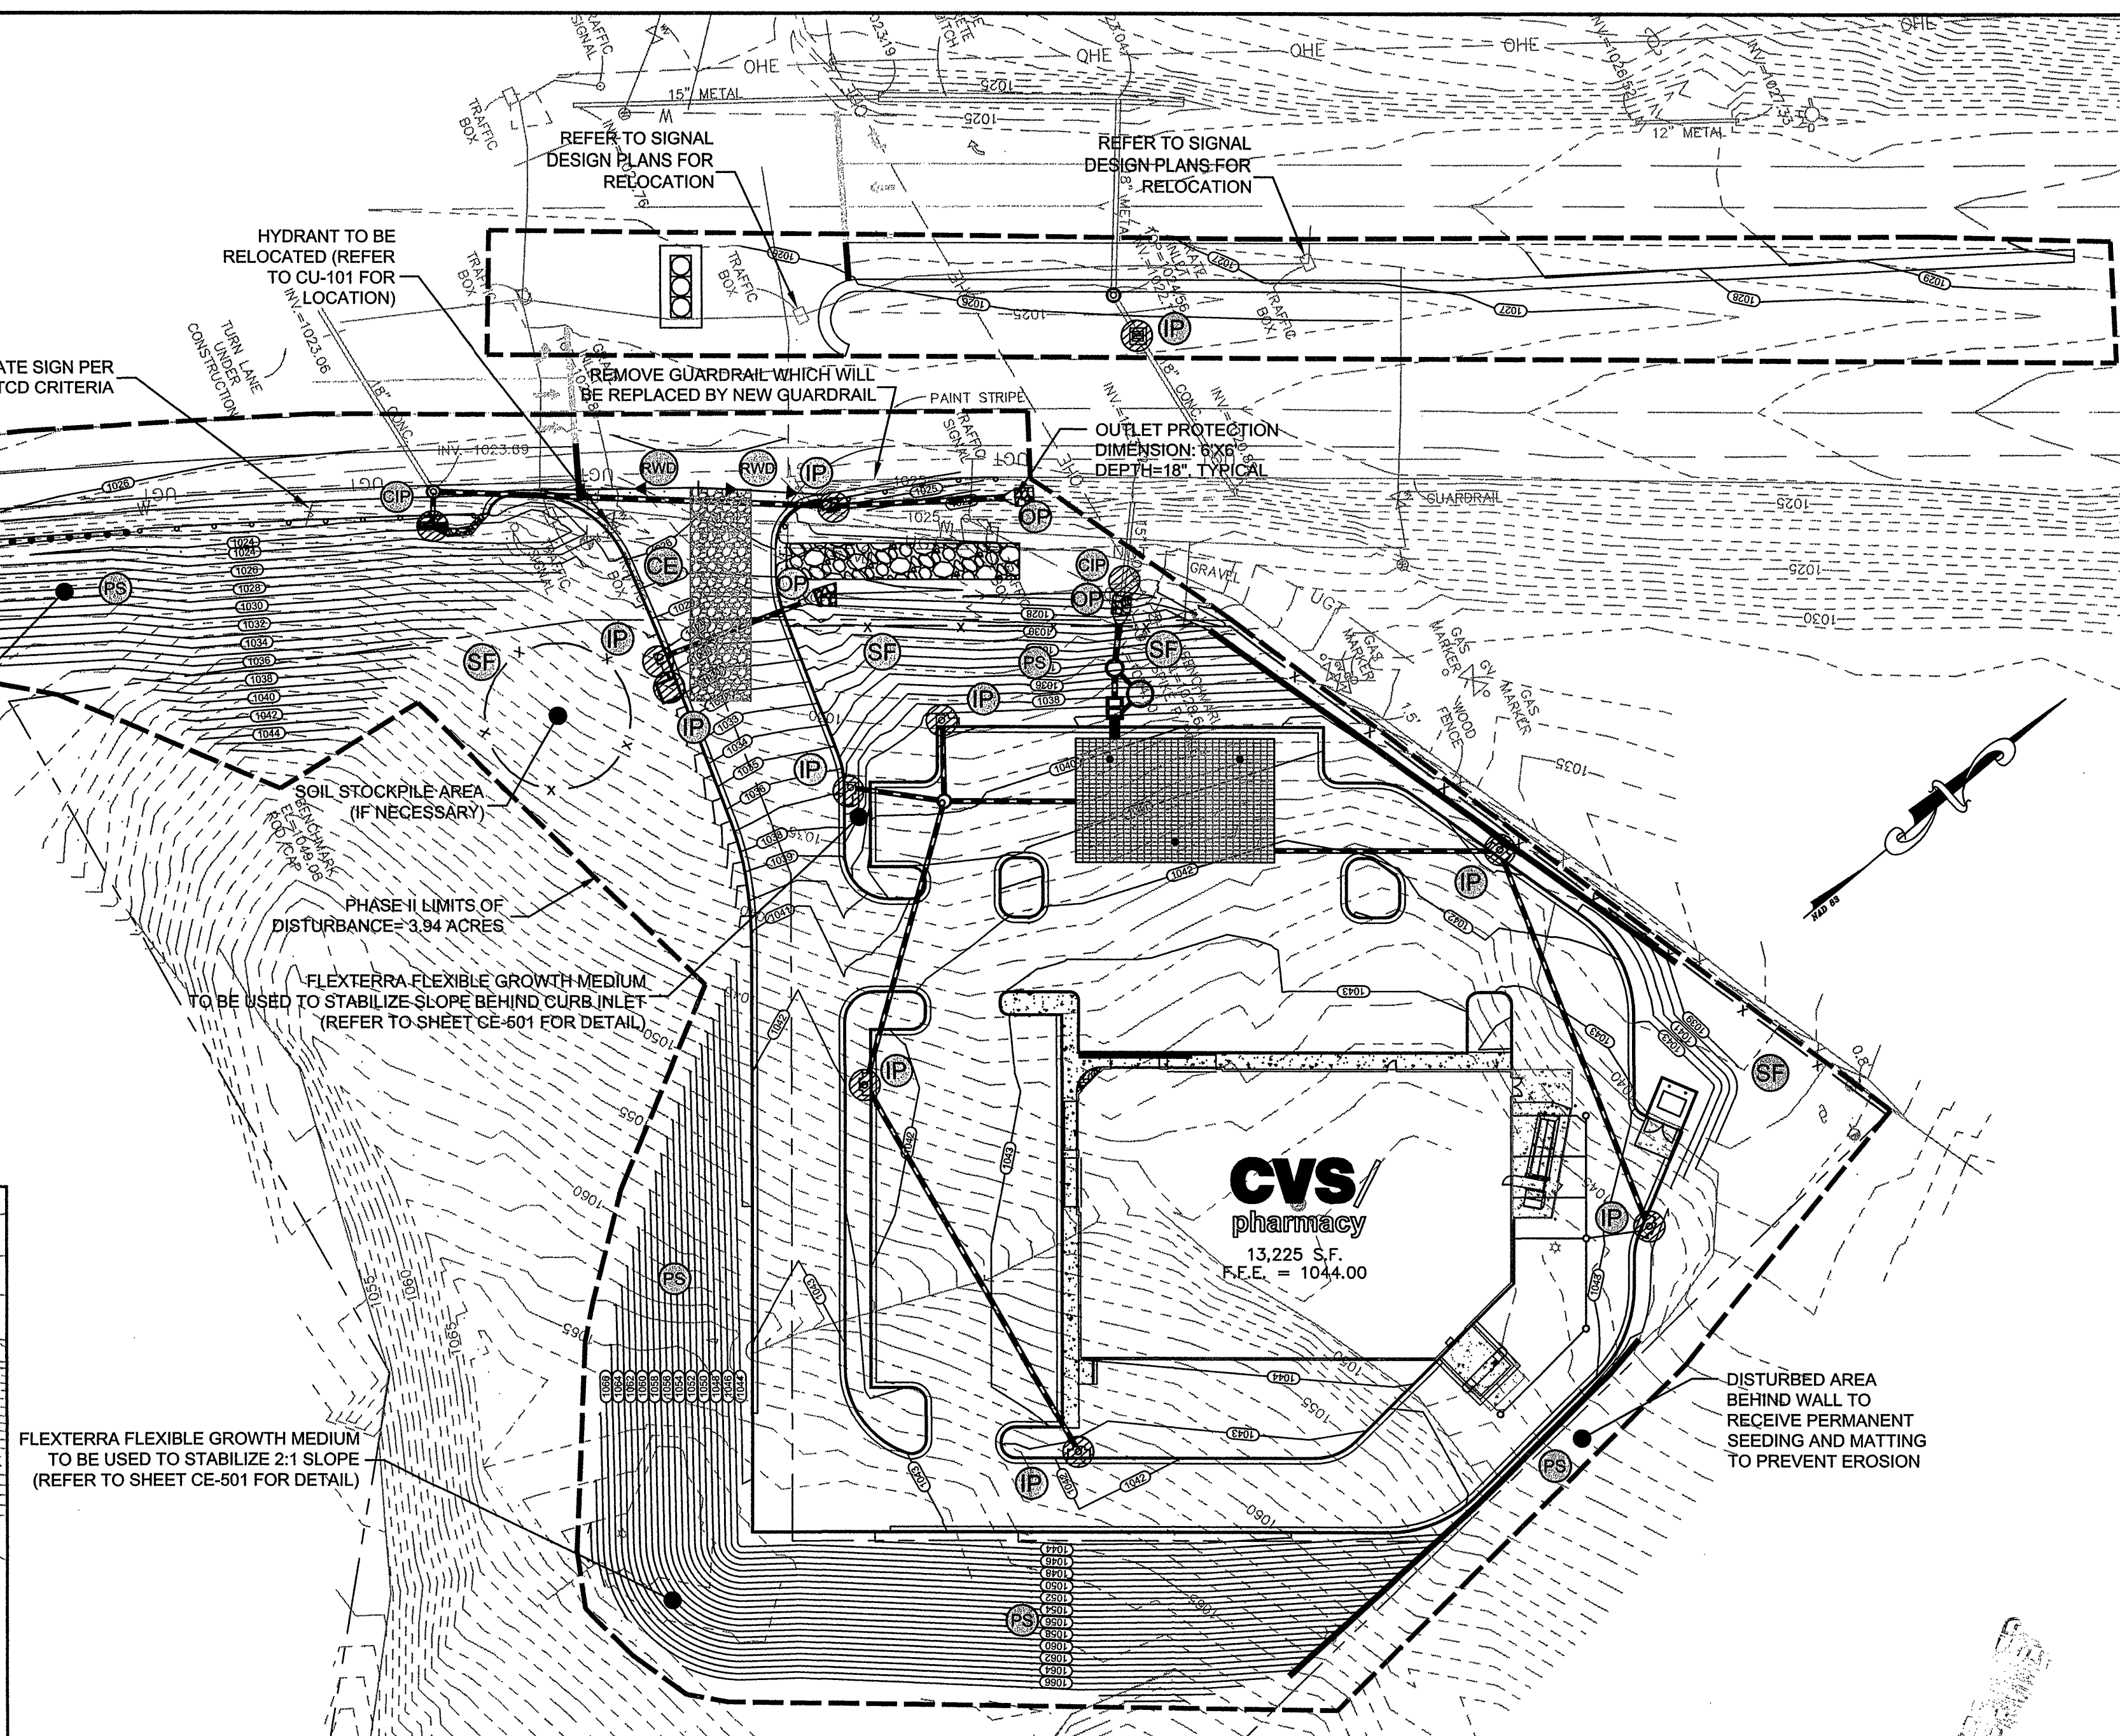

PHASE II EROSION CONTROL PLAN

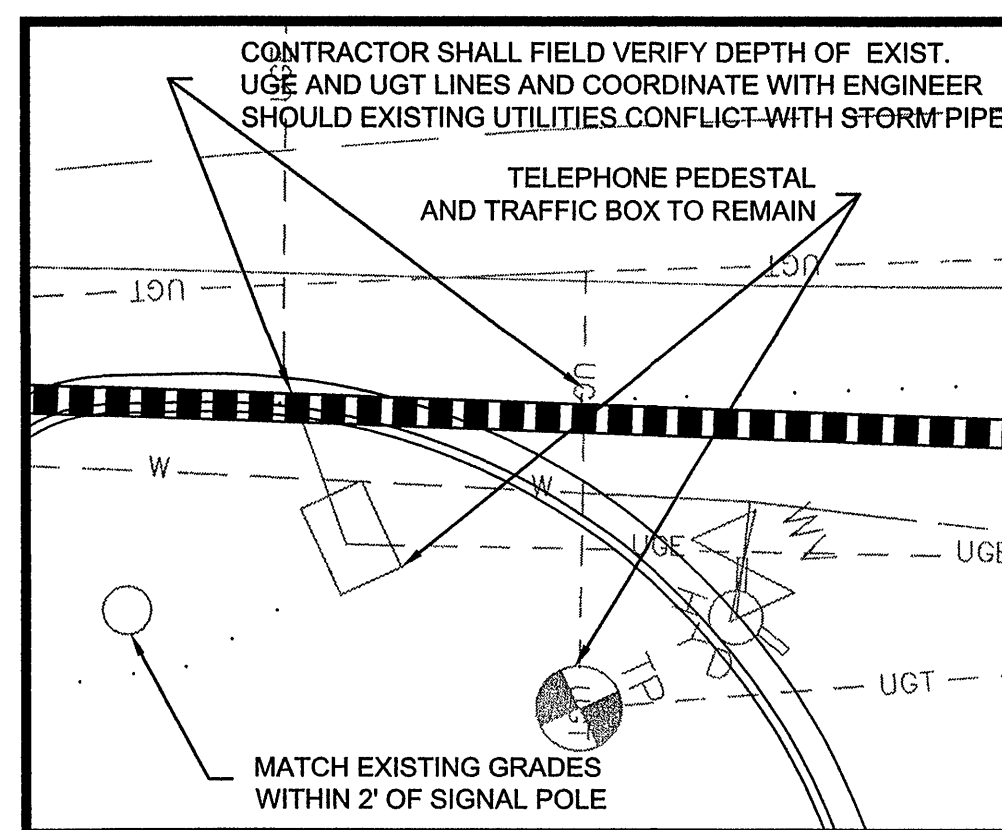


INSET A
SCALE: 1"=10'

PHASE I CONSTRUCTION SEQUENCE

- TURN LANES AND NEW ENTRANCE**
1. INSTALL ALL EROSION AND SEDIMENT CONTROL MEASURES. CALL VDOT FOR INSPECTION.
 2. CLEAR AND GRUB.
 3. ROUGH GRADE.
 4. INSTALL INLET PROTECTION ON ALL STORM SEWER STRUCTURES AS EACH STRUCTURE IS INSTALLED.
 5. PAVE AND STRIPE THE TURN LANES AND ENTRANCES.
 6. REMOVE TEMPORARY EROSION AND SEDIMENT CONTROL DEVICES AND PERMANENTLY STABILIZE ALL DISTURBED AREAS.
- CVS SITE**
7. COORDINATE PRECONSTRUCTION MEETING WITH E&S INSPECTOR.
 8. INSTALL STABILIZED CONSTRUCTION ENTRANCE.
 9. INSTALL REMAINING EROSION CONTROL MEASURES INCLUDING SLOPE PROTECTION, INLET PROTECTION, THE SEDIMENT TRAP AND THE DIVERSION DIKES.
 10. BEGIN DEMOLITION, CLEARING, AND GRUBBING.
 11. BEGIN ROUGH GRADING AND EARTHWORK OPERATIONS.
 12. BEGIN CONSTRUCTION OF RETAINING WALLS AND CVS STORM PIPE INSTALLATION. INSTALL ALL CVS STORM PIPE AND STRUCTURES (INCLUDING INLET PROTECTION) WHICH CONVEYS RUNOFF TO THE FUTURE RAINTANK SYSTEM.
 13. TEMPORARILY SEED AND MULCH (USING STRAW) ALL DENUDED AREAS THAT WILL REMAIN DORMANT FOR 30 DAYS OR MORE, WITHIN 7 DAYS. SOD ALL DENUDED AREAS THAT HAVE REACHED FINAL GRADE AND WILL BE DORMANT MORE THAN ONE YEAR, WITHIN 7 DAYS.

PHASE II CONSTRUCTION SEQUENCE

1. COMPLETE STORM DRAINAGE PIPE INSTALLATION, INSTALL INLET PROTECTION AT ALL SPECIFIED LOCATIONS.
2. CLEANOUT SEDIMENT TRAP AND CONVERT TO RAINWATER DETENTION SYSTEM EXCAVATION FOOTPRINT.
3. INSTALL RAINWATER SYSTEM DURING DRY CONDITIONS.
4. CONTRACTOR TO INSTALL WATERMAIN, SANITARY SEWER, COLD WATER SEWER, STORMFILTER, AND ALL REMAINING UNDER GROUND UTILITIES.
5. START CONSTRUCTION OF BUILDING PAD.
6. PERMANENTLY STABILIZE AREAS TO BE VEGETATED AS THEY ARE BROUGHT TO FINAL GRADE.
7. PREPARE THE SITE FOR PAVING AND INSTALL CURB AND GUTTER.
8. PAVE THE SITE.
9. PLACE TOPSOIL ON ALL LANDSCAPE AREAS. SOIL ALL DENUDDED AREAS. ACTIVATE STORMFILTER SYSTEM.
10. REMOVE ALL TEMPORARY EROSION AND SEDIMENT CONTROL MEASURES IN ACCORDANCE WITH THE LATEST EDITION OF THE VIRGINIA EROSION AND SEDIMENT CONTROL HANDBOOK. DO NOT REMOVE EROSION CONTROL MEASURES UNTIL THE ENTIRE SITE HAS BEEN PERMANENTLY STABILIZED.

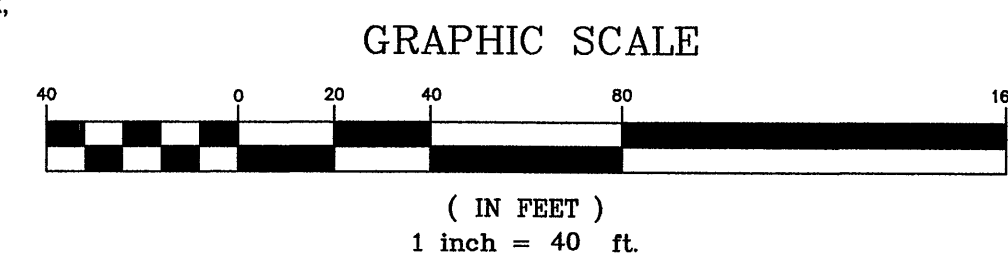


Kimley-Horn
and Associates, Inc.

1500 FOREST AVENUE, SUITE 115
RICHMOND, VIRGINIA 23229

CONSULTANT:

KIMLEY-HORN AND ASSOCIATES, INC.
1500 FOREST AVENUE, SUITE 115
RICHMOND, VA 23229
PHONE: (804) 673-3882
FAX: (804) 673-3980

SEAL:

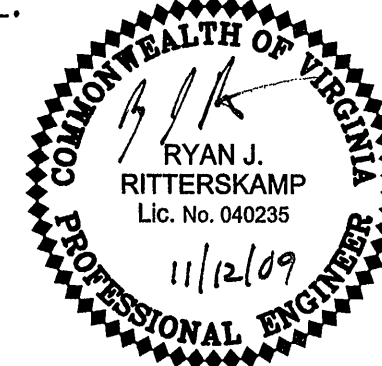

CVS/
pharmacy

13,225 S.F. PROTOTYPE
STORE NUMBER: 7503

INTERSECTION OF
ROUTE 460 & ROUTE 610
ROANOKE, VIRGINIA

OWNER/DEVELOPER:

THE REBKEE COMPANY
15871 CITY VIEW DRIVE, SUITE 300
MIDLOTHIAN, VA 23113
PHONE: (804) 419-0740
FAX: (804) 419-0759

REVISIONS:

| | |
|---------------|-----------|
| LAYOUT COORD: | RRP |
| PLANNING MGR. | DBE |
| DRAWING BY: | DHL |
| DATE: | 11/12/09 |
| JOB NUMBER: | 113001106 |
| TITLE: | |

E&S PLAN

SHEET NUMBER:

CE-101

COMMENTS: