



INITIAL EROSION AND SEDIMENT CONTROL MEASURES / CONSTRUCTION SEQUENCE:

- CONSTRUCTION WILL BE SEQUENCED TO INSTALL INITIAL EROSION AND SEDIMENT CONTROL MEASURES PRIOR TO DEMOLITION.

 CONTRACTOR SHALL INSTALL CONSTRUCTION ENTRANCE AS SHOWN ON PLANS. CONTRACTOR SHALL MAINTAIN THE CONSTRUCTION ENTRANCE PER VA ESCH STD. & SPEC 3.02.
- AFTER THE INITIAL MEASURES ARE INSTALLED, THE CONTRACTOR MAY BEGIN CONSTRUCTION.
 TOPSOIL STOCKPILING IS NOT ANTICIPATED FOR THIS PROJECT. IF REQUIRED, SUITABLE LOCATIONS ARE TO BE DETERMINED BY THE CONTRACTOR. SILT FENCE SHALL BE PLACED AROUND THE PERIMETER OF THE STOCKPILE. TEMPORARY SEEDING MEASURES APPLY TO STOCKPILES.
- THE CONTRACTOR SHALL CHECK AND VERIFY ALL EXISTING PERIMETER EROSION AND SEDIMENT CONTROL MEASURES AROUND THE SITE. ANY PERIMETER EROSION CONTROL MEASURES THAT ARE DAMAGED SHALL BE REPAIRED TO CONTROL SEDIMENT LADEN RUNOFF FROM ENTERING ADJACENT PROPERTIES AND/OR STREAMS AND SWALES.
- IN ANY AREAS WHERE SEDIMENT LADEN WATER IS BEING PUMPED FROM A LOCATION, THE PUMPED RUNOFF SHALL BE FILTERED THROUGH A "FILTER BAG" BEFORE BEING RELEASED.
- THE CONTRACTOR SHALL KEEP MATERIALS AND EQUIPMENT ON—SITE TO KEEP DUST LEVELS AT A MINIMUM.
 THE CONTRACTOR SHALL MAINTAIN THE EROSION AND SEDIMENT CONTROL MEASURES AS IDENTIFIED UNDER THE "MAINTENANCE" SECTION OF THIS DOCUMENT.
- ALL VEGETATIVE AND STRUCTURAL EROSION AND SEDIMENT CONTROL PRACTICES WILL BE CONSTRUCTED AND MAINTAINED ACCORDING TO MINIMUM STANDARDS AND SPECIFICATIONS OF THE VIRGINIA EROSION AND SEDIMENT CONTROL HANDBOOK (VA ESCH).
- ALL DISTURBED AREAS ARE TO DRAIN TO APPROVED SEDIMENT CONTROL MEASURES AT ALL TIMES DURING LAND DISTURBING ACTIVITIES AND DURING SITE DEVELOPMENT UNTIL FINAL STABILIZATION IS REACHED.
- THE CONTRACTOR IS RESPONSIBLE FOR THE INSTALLATION OF ANY ADDITIONAL EROSION CONTROL MEASURES
- NECESSARY TO PREVENT EROSION AND SEDIMENTATION AS DETERMINED BY THE LOCAL AUTHORITY.

 THE CONTRACTOR SHALL INSPECT ALL EROSION CONTROL MEASURES PERIODICALLY AND AFTER EACH RUNOFF PRODUCING RAINFALL EVENT. ANY NECESSARY REPAIRS OR CLEANUP TO MAINTAIN THE EFFECTIVENESS OF THE EROSION CONTROL DEVICES SHALL BE MADE IMMEDIATELY.

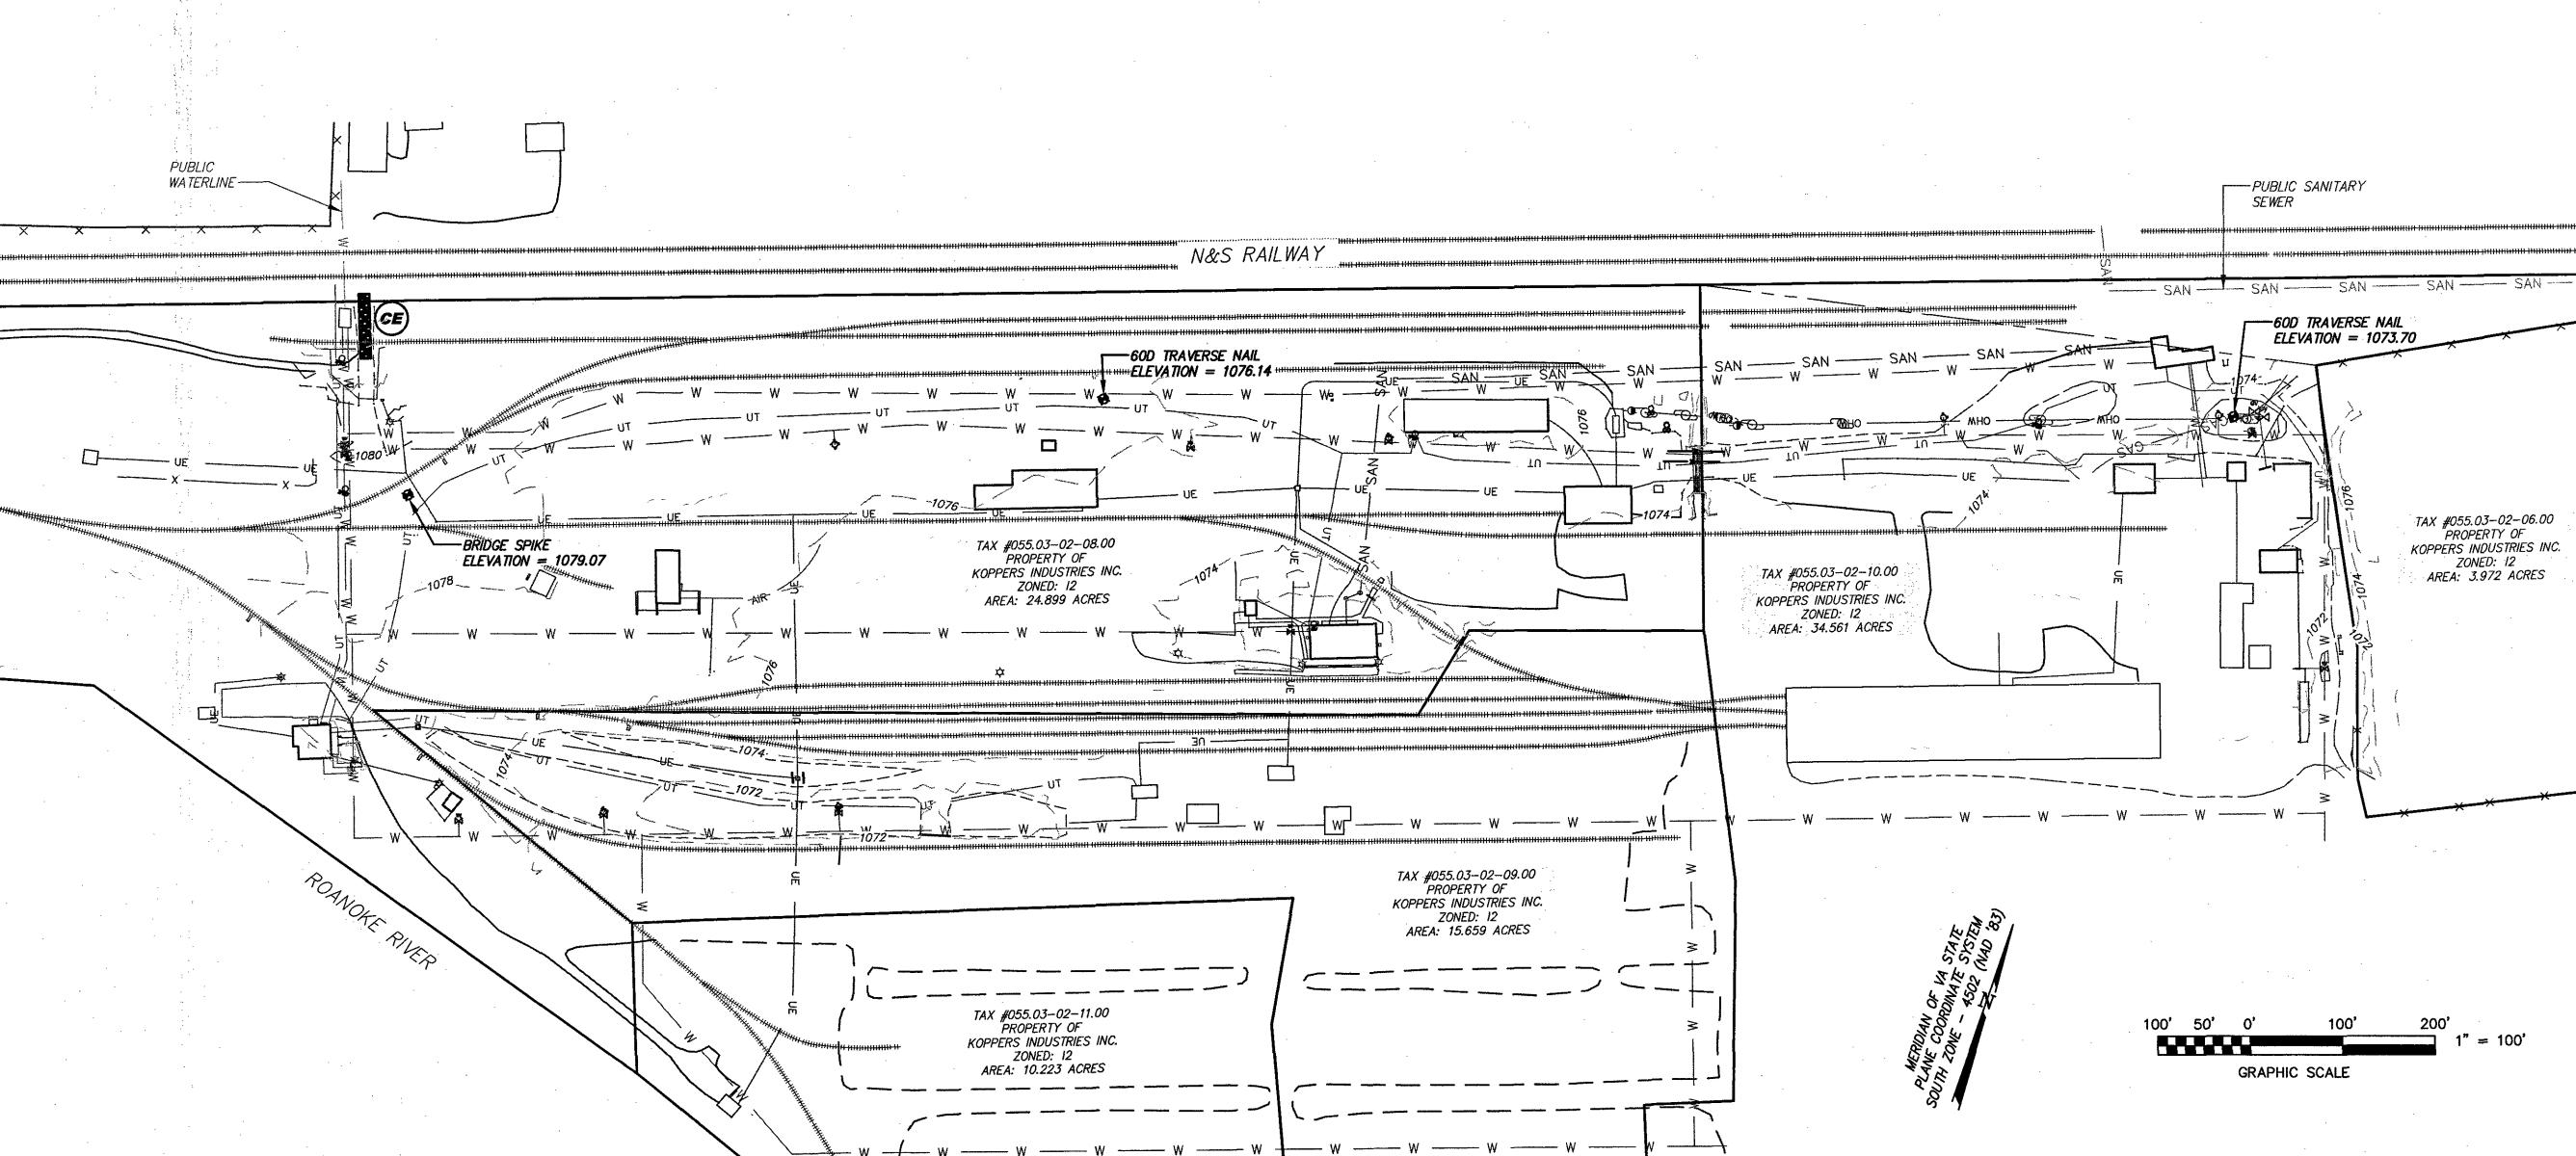

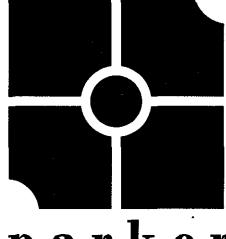

parker DESIGN GROUP

2122 Carolina Ave, SW 1915-B W. Cary Street Roanoke, VA 24014 Richmond, VA 23220 Ph: 540-387-1153 Phone: 804-358-2947 Fax: 540-389-5767 Fax: 804-359-9645

89-5767 Fax: 804-35 www.parkerdg.com

These documents are the property of Parker Design Group(PDG) and may not be reproduced or used without the express permission of PDG. Any reuse of these documents without authorization of PDG will be at the sole risk of the individual or entity utilizing said documents.



oppers Waterline Extension for Koppers Industries, Inc. 4020 Koppers Road

REVISIONS:

DESIGNED BY: JF

DRAWN BY: JPA

CHECKED BY: SLR

SCALE: 1" = 100'

SCALE: 1" = 100'

DATE: 07 April 2017

SHEET TITLE:

EXISTING CONDITIONS & INITIAL ESC PLAN

CO2
02 OF 09
PROJECT NUMBER:
16-0151-03