INV. OUT=921.9

 $\langle C \rangle$ - $\langle F \rangle$ 7 LF OF 6" SDR-35 PVC AT 3.08% BLDG $-\langle D \rangle$ 5 LF OF 6" SDR-35 PVC AT 4.00% (INV. AT BLDG. 923.2)

PRIVATE S.S. C.O. W/TRAFFIC BEARING LID TOP=926.9 INV.=923.0

 \bigcirc - \bigcirc SDR-35 PVC AT 2.82%

PRIVATE S.S. C.O. W/TRAFFIC BEARING LID TOP=925.66 INV.=922.2

 $\langle E \rangle$ - $\langle F \rangle$ 10 LF OF 6" SDR-35 PVC AT 1.98%

PRIVATE S.S. C.O. W/TRAFFIC BEARING LID TOP = 25.49INV.=921.7

 $-\langle G \rangle$ 26 LF OF 6" SDR-35 PVC AT 5.33%

PUBLIC S.S. C.O. W/TRAFFIC BEARING LID TOP=923.76 INV.=920.3

 \bigcirc - \bigcirc 13 LF OF 6" SDR-26 PVC AT 1.56%

INV. OUT= 920.1

1. G.C. TO CONFIRM & COORDINATE ALL BUILDING TIE-IN LOCATIONS WITH M.E.P. AND ARCHITECTURAL DRAWINGS PRIOR TO CONSTRUCTION OF LATERALS. 2. G.C. TO CONFIRM ALL TIE-IN LOCATIONS TO EXISTING LINES PRIOR TO CONSTRUCTION AND NOTIFY THE ENGINEER OF ANY DISCREPANCIES.

DRIVE-THROUGH NOTES:

1. STACKING SPACES REQUIRED: 5 PROVIDED: (5) 10'x20' SPACES

-2" SM-9.5A

-8" VDOT 21A

(COMPACTED)

__2" SM-9.5A

-2" IM-19.0A

6" VDOT 21A

(COMPACTED)

ベング////ネーティング//メング (SUBGRADE— MIN 95% COMPACTION)

ベング//// かた アンストンストング (SUBGRADE - MIN 95% COMPACTION)

STANDARD ON-SITE ASPHALT PAVEMENT SECTION

3. G.C. TO ENSURE A MINIMUM OF 95% COMPACTION OF THE SUBGRADE PRIOR TO STONE/ASPHALT PLACEMENT.

NO SCALE

NO SCALE

3. G.C. TO ENSURE A MINIMUM OF 95% COMPACTION OF THE SUBGRADE PRIOR TO STONE/ASPHALT PLACEMENT.

I. STONE BASE MUST BE PLACED IN LIFTS OF NO MORE THAN 4" EACH.


2. A TACK COAT SHALL BE APPLIED BETWEEN ASPHALT PAVEMENT LAYERS.


1. STONE BASE MUST BE PLACED IN LIFTS OF NO MORE THAN 4" EACH

2. A TACK COAT SHALL BE APPLIED BETWEEN ASPHALT PAVEMENT LAYERS

SPEAKERS SHALL BE LOCATED AT LEAST 50 FEET FROM THE PROPERTY LINE OF ANY RESIDENTIALLY ZONED PROPERTY.

MENU BOARDS, WHICH SHALL NOT COUNT TOWARD FREESTANDING SIGN ALLOCATIONS, SHALL BE A MAXIMUM OF 50 SQUARE FEET, WITH A MAXIMUM HEIGHT OF 8 FEET.

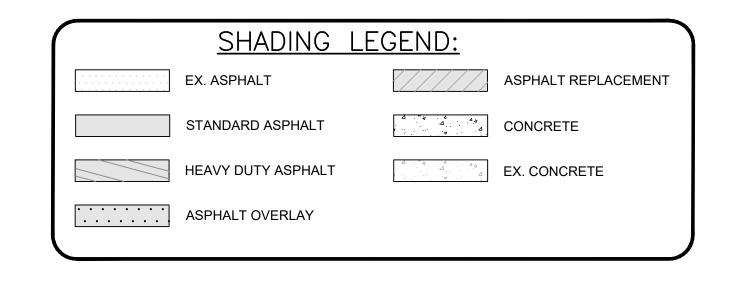

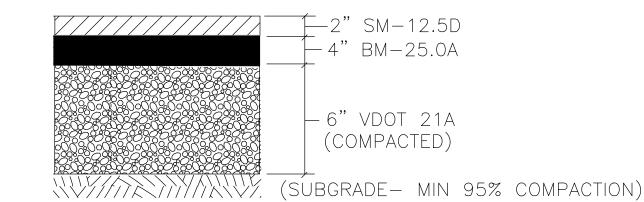

ALLEY ASPHALT PAVEMENT SECTION

NO SCALE

15" Conc. Inv. Out: 912.6

GENERAL SITE NOTES:

1. G.C. TO CONFIRM THE LOCATION OF ALL EXISTING UTILITIES PRIOR TO ANY CONSTRUCTION OF PROPOSED IMPROVEMENTS.

2. NO CONSTRUCTION/FIELD CHANGES WITHOUT THE APPROVAL OF THE CONSULTING ENGINEER. W.V.W.A., AND CITY OF ROANOKE PLANNING, BUILDING, AND DEVELOPMENT DEPARTMENT. G.C SHALL OBTAIN A RIGHT OF WAY PERMIT FROM THE CITY OF ROANOKE PRIOR TO ANY WORK WITHIN THE CITY OF ROANOKE R.O.W.

3. GENERAL CONTRACTOR TO FIELD VERIFY PAVEMENT TIE IN LOCATIONS/ELEVATIONS AND ENSURE THAT POSITIVE DRAINAGE AWAY FROM THE PROPOSED BUILDING IS MAINTAINED THROUGHOUT THE SITE.

4. ANY PAVEMENT TO REMAIN THAT IS DISTURBED OR DESTROYED DURING THE CONSTRUCTION PROCESS SHALL BE REPAIRED/REPLACED AS NECESSARY TO PRE-CONSTRUCTION CONDITIONS AT NO COST TO THE OWNER.

5. ALL BUILDING DIMENSIONS AND UTILITY CONNECTIONS SHALL BE COORDINATED WITH THE ARCHITECTURAL PLANS. 6. G.C. SHALL SUBMIT A TRAFFIC CONTROL PLAN TO THE CITY OF ROANOKE PRIOR TO ANY CONSTRUCTION WITHIN THE PUBLIC RIGHT-OF-WAY.

7. G.C. TO PROVIDE ALL REQUIRED CONDUIT FOR EXTERIOR LIGHTING, ELECTRICAL, TELEPHONE, AND COMMUNICATIONS. ALL UTILITIES TO BE INSTALLED UNDERGROUND.

8. G.C. SHALL COORDINATE CONCRETE FINISHING AROUND THE PROPOSED DOOR LOCATIONS WITH THE ARCHITECTURAL PLANS.

9. THE SITE CONTRACTOR MUST COORDINATE THE TIMING AND INSTALLATION OF ALL UTILITIES AND MAKE ALL NECESSARY SCHEDULE ARANGEMENTS FOR TEMPORARY OR PERMANENT UTILITIES PER THE PROJECT SCHEDULE.

10. ALL ROOFTOP OR GROUND MOUNTED MECHANICAL EQUIPMENT SHALL BE SCREENED FROM VIEW PER CITY OF ROANOKE ZONING ORDINANCE. THE PERIMETER OF ALL GROUND-MOUNTED EQUIPMENT SHALL BE SCREENED FROM ANY STREET FRONTAGE OR ADJACENT PROPERTY BY A FENCE OR SOLID WALL WITH 60% OR GREATER OPACITY. THE PERIMETER OF ALL ROOFTOP EQUIPMENT THAT WOULD OTHERWISE BE VISIBLE FROM ANY STREET FRONTAGE SHALL BE SCREENED BY A FENCE OR SOLID WALL WITH 60% OR GREATER OPACITY AT LEAST 1/2 THE VERTICIAL HEIGHT OF THE EQUIPMENT FROM THE ADJACENT STREET. TO BE VERIFIED BY SUBMISSION OF A FIELD REVISION TO THE DEVELOPMENT PLAN OR SEPARATE BUILDING PERMIT.


11. G.C. SHALL OBTAIN A SEPARATE SIGN PERMIT FOR ALL ON-SITE AND BUILDING SIGNAGE. IF A FLAGPOLE DISPLAY IS PROPOSED, NOTE THAT ONLY FLAGS TO BE DISPLAYED ARE NATIONAL, STATE, OR OTHER GOVERNMENTAL FLAGS AND INSIGNIAS.

12.THE REFUSE CONTAINER STORAGE AREA MUST MEET ALL REQUIREMENTS SET FORTH IN TABLE 647-1 AND ARTICLE 4. SUPPLEMENTAL REGULATION SECTION OF THE ZONING ORDINANCE. THE HEIGHT OF THE SCREENING MUST BE AT LEAST 12" ABOVE THE TOP OF THE CONTAINER AND THE OPACITY OF THE SCREENING MUST BE A SOLID FENCE MATERIAL. SEE ENCLOSURE AND GATE DETAILS.

13. ALL EXTERIOR LIGHTING SHALL BE INSTALLED IN ACCORDANCE WITH THE APPROVED LIGHTING PLAN AND CUT SHEETS. THE LIGHTING SHALL ALSO BE INSTALLED AND AIMED TO MEET ALL REQUIREMENTS SET FORTH IN SECTION 36.2 DIVISION 2 OUTDOOR LIGHTING.

14. ALL DOWNSPOUTS SHALL BE COLLECTED BY UNDERGROUND PIPING AND CONNECTED TO THE STORM SEWER SYSTEM AS

(SS)

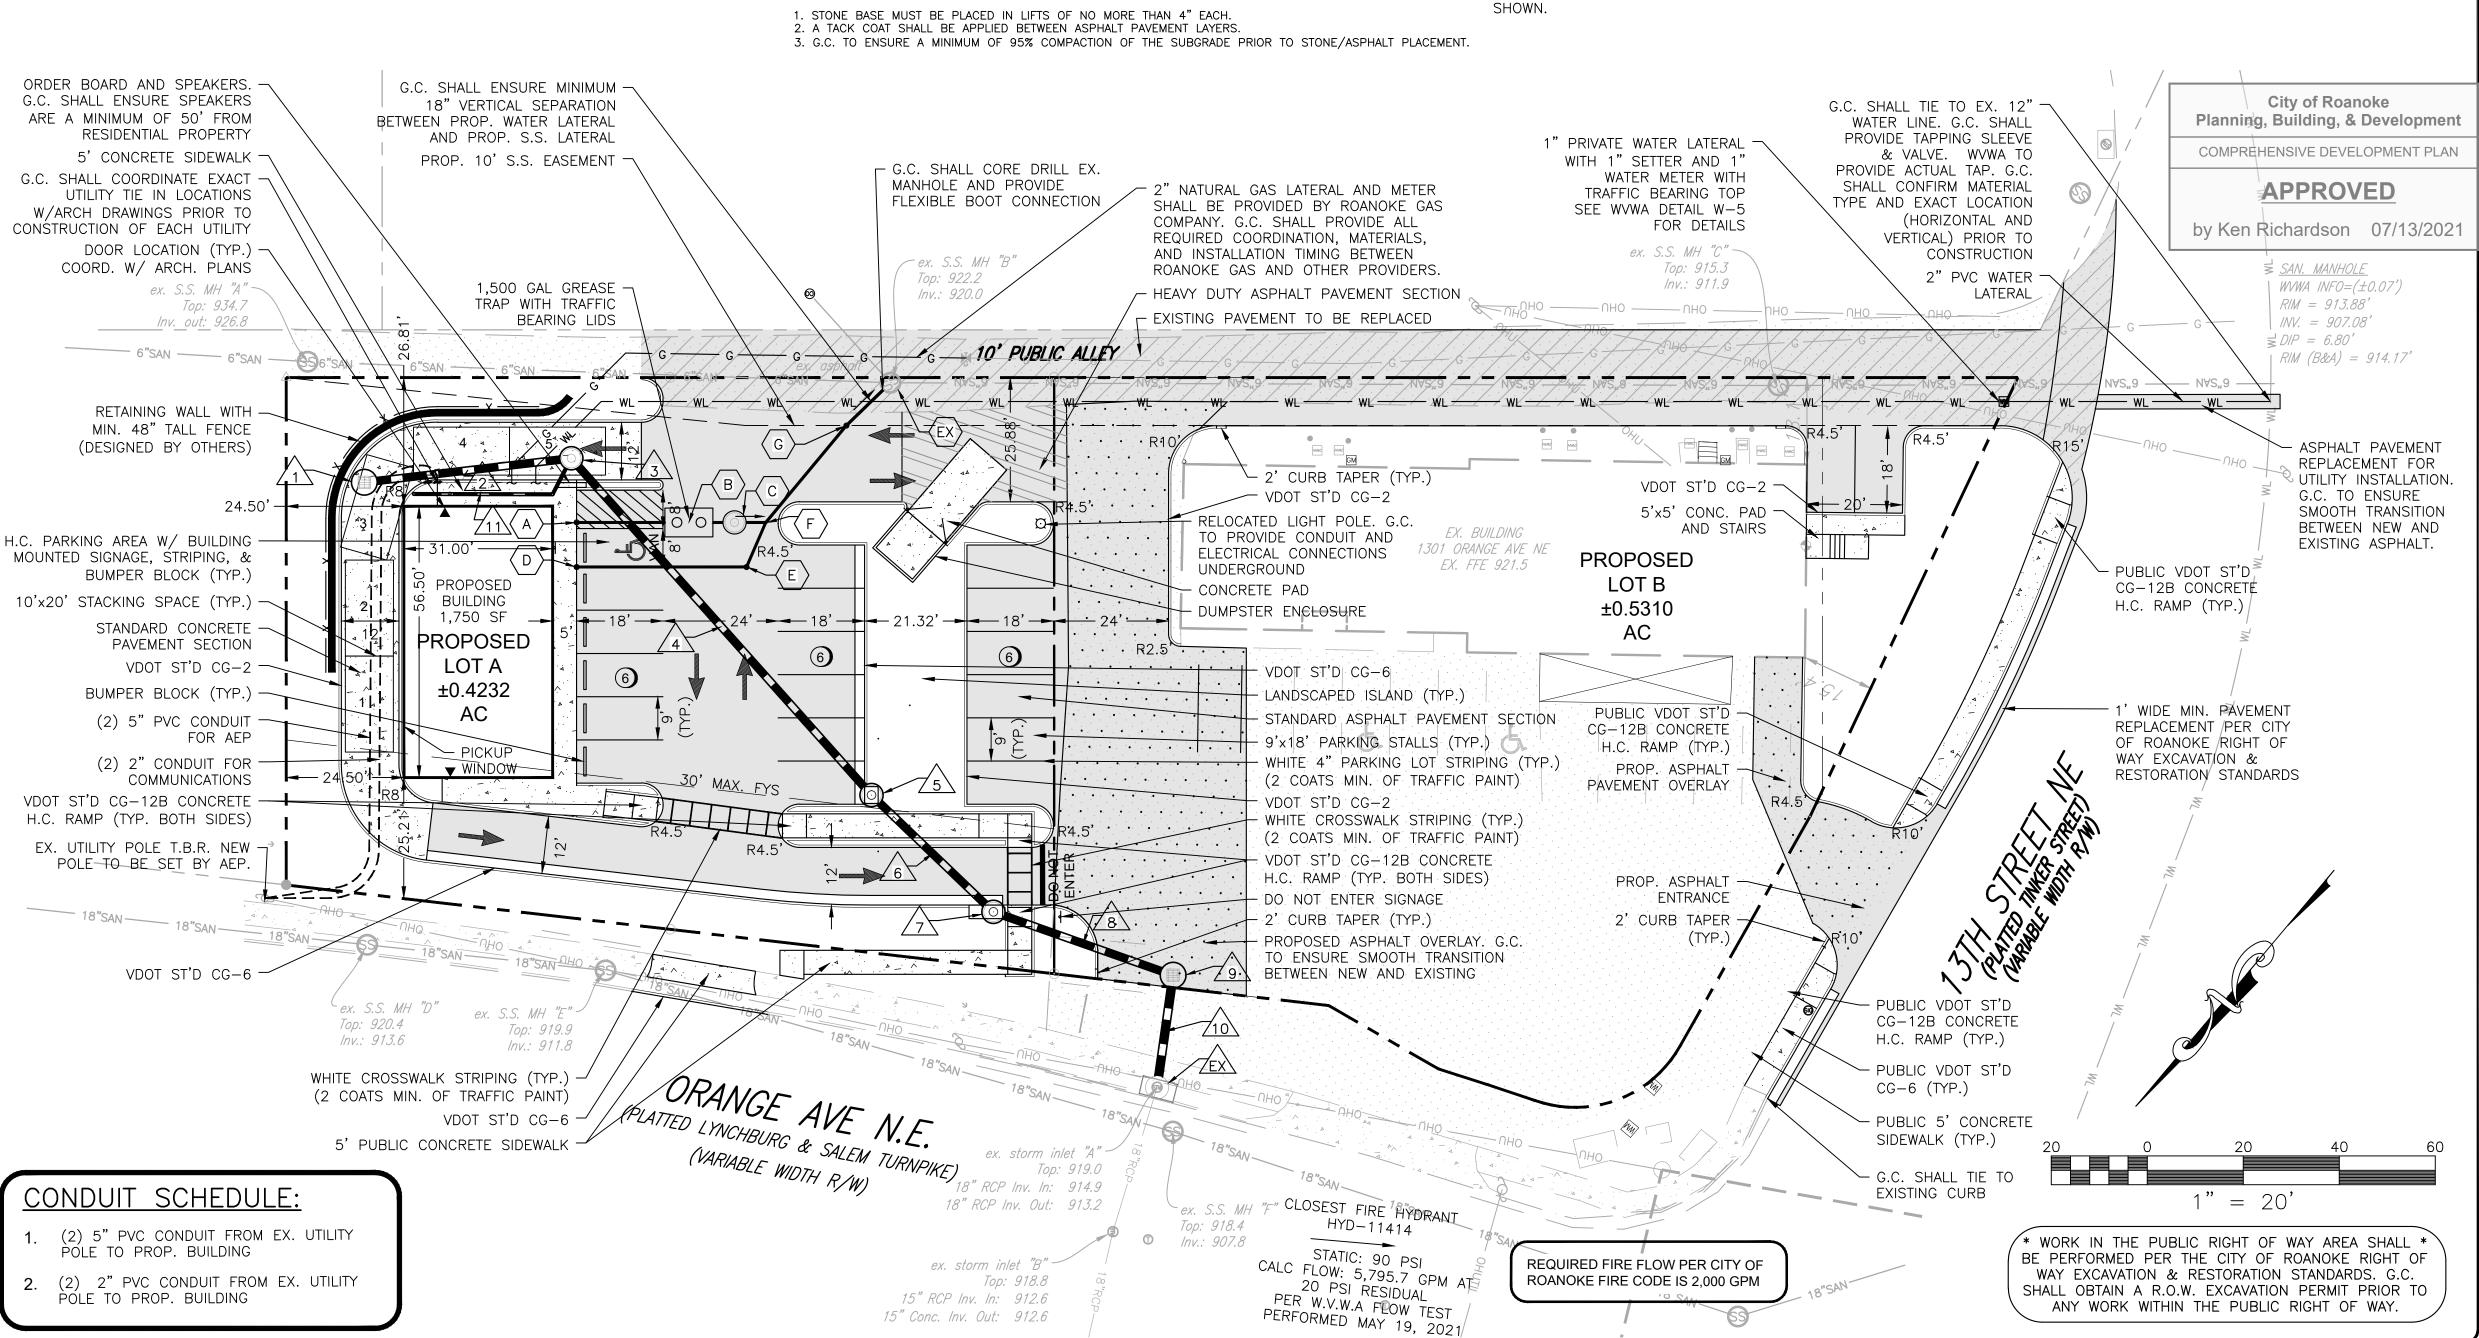

ENGINEERS / SURVEYORS

Roanoke / Richmond New River Valley / Staunton Harrisonburg / Lynchburg www.balzer.cc

1208 Corporate Circle Roanoke, VA 24018 540.772.9580



G

DRAWN BY **DESIGNED BY CHECKED BY** DATE SCALE

6/11/2021 1"=20' REVISIONS