SITE SUMMARY:

CITY PROJECT NO.

MEMBER ONE FEDERAL CREDIT UNION

202 4TH STREET NE **PROPERTY ADDRESS**

CITY OF ROANOKE, VIRGINIA

PARCEL NUMBER

3015008 DOWNTOWN

PROPERTY ZONING **PROPOSED USE** DRIVE-THROUGH FACILITY (BANK)

(SPECIAL EXCEPTION REQUIRED, 36.2-315)

BZA ORDER

BZAS20-0017 (AMENDED CONDITIONS SHOWN ON C07)

D - DOWNTOWN SITE AREA

6.36 ACRES

NONE

5.10 ACRES

LIMITS OF DISTURBANCE

BUILDING AREA/FLOORS

BUILDING HEIGHT TBD

MIN. PARKING REQ'D

PARKING PROPOSED

PHASE 2: 223 EX. + 0 PROP. = 223 TOTAL PHASE 3: 144 EX. + 126 PROP. = 270 TOTAL

PHASE 1: 116 EX. + 107 PROP. = 223TOTAL


PHASE 4: 259 EX. + 39 PROP. = 298 TOTAL TOTAL 298 (INCL. ADA); EXCEEDS MAXIMUM

ROANOKE CITY CONSTRUCTION PROCEDURE REQUIREMENTS:

- ALTERATION OR CONSTRUCTION WITHIN THE PUBLIC RIGHT-OF-WAY (STREETS, ALLEYS, PUBLIC EASEMENTS). A RIGHT-OF-WAY EXCAVATION PERMIT SHALL BE APPLIED FOR AND OBTAINED BY THE CONTRACTOR FROM THE CITY OF ROANOKE
- ANY BORROW/FILL SITES ASSOCIATED WITH THE PROJECT MUST BE SUBMITTED PRIOR TO THE ISSUANCE OF A LAND DISTURBANCE PERMIT
- PLANS AND PERMITS A COPY OF THE PLANS AS APPROVED BY THE CITY (SIGNED BY THE PROPER CITY OFFICIALS) AND ALL PERMITS ISSUED BY THE CITY SHALL BE AVAILABLE AT THE CONSTRUCTION SITE AT ALL TIMES OF ONGOING CONSTRUCTION.
- 4. LOCATION OF UTILITIES THE CONTRACTOR SHALL VERIFY THE LOCATION OF ALL EXISTING
- CONSTRUCTION ENTRANCE THE CONTRACTOR SHALL INSTALL AN ADEQUATE CONSTRUCTION ENTRANCE FOR ALL CONSTRUCTION RELATED EGRESS FROM THE SITE. SIZE AND COMPOSITION OF CONSTRUCTION ENTRANCE SHALL BE AS SHOWN ON THE PLANS.
- STREETS TO REMAIN CLEAN IT SHALL BE THE RESPONSIBILITY OF THE CONTRACTOR TO INSURE THAT THE PUBLIC STREET ADJACENT TO THE CONSTRUCTION ENTRANCE REMAINS FREE OF MUD. DIRT. DUST. AND/OR ANY TYPE OF CONSTRUCTION MATERIALS OR LITTER AT ALL TIMES.
- 7. BARRICADES/DITCHES THE CONTRACTOR SHALL MAINTAIN THE INTEGRITY OF ALL EXCAVATED DITCHES AND SHALL FURNISH AND ENSURE THAT ALL BARRICADES PROPER AND NECESSARY FOR THE SAFETY OF THE PUBLIC ARE IN PLACE.
- SEWER AND PAVEMENT REPLACEMENT CONSTRUCTION OF SANITARY SEWERS AND THE REPLACEMENT OF PAVEMENT SHALL BE IN ACCORDANCE WITH APPROVED STANDARDS AND SPECIFICATIONS OF THE CITY OF ROANOKE AND THE WESTERN VIRGINIA WATER AUTHORITY
- APPROVED PLANS/CONSTRUCTION CHANGES ANY CHANGE OR VARIATION FROM CONSTRUCTION DESIGN AS SHOWN ON THE OFFICIALLY APPROVED PLANS SHALL BE APPROVED BY THE EROSION AND SEDIMENT CONTROL AGENT PRIOR TO SAID CHANGES OR VARIATION IN CONSTRUCTION BEING MADE.
- 10. FINAL ACCEPTANCE/CITY THE OWNER OR DEVELOPER SHALL FURNISH THE CITY OF ROANOKE'S PLANNING BUILDING AND DEVELOPMENT DEPARTMENT WITH A FIELD SURVEYED FINAL CORRECT SET OF AS-BUILT PLANS OF THE NEWLY CONSTRUCTED STORM RAIN AND/OR STORMWATER MANAGEMENT FACILITIES PRIOR TO FINAL ACCEPTANCE AND ISSUANCE OF A CERTIFICATE OF OCCUPANCY BY THE CITY. AS-BUILT PLANS SHALL BE PROVIDED IN THE STATE PLANE VIRGINIA SOUTH COORDINATE SYSTEM, NAD 1983, FIPS 4502 FEET, US SURVEY FEET, DATUM NA 83, IN THE FORM OF 1 PAPER COPY AND 1 DIGITAL AUTOCAD FILE.
- 11. RIGHT-OF-WAY CONSTRUCTION "WORK IN THIS AREA IS TO BE PERFORMED PER THE CITY OF ROANOKE RIGHT OF WAY EXCAVATION AND RESTORATION STANDARDS".

CITY APPROVALS

FIELD REVISION #1 FOR SITE PLANS HEADQUARTERS CAMPUS DEVELOPMENT MEMBER ONE FEDERAL CREDIT UNION JULY 08, 2021

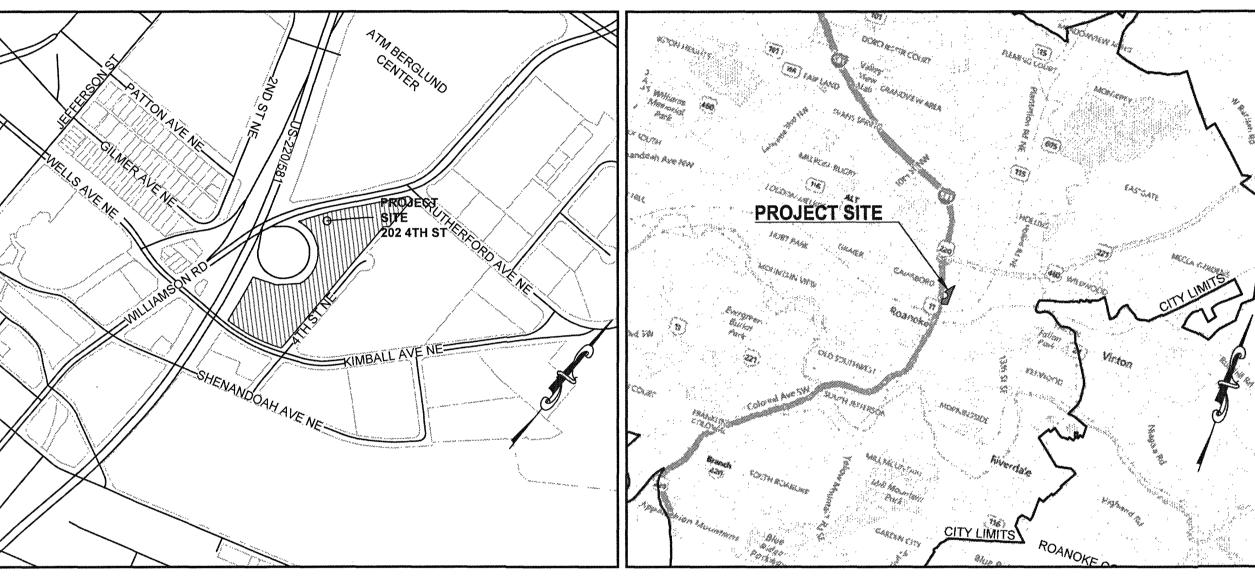

VICINITY MAP 1" = 500'

Parker Design Group, Inc

Interactive Design Group, Inc.

2122 Carolina Ave SW

Roanoke, VA 24014

PH: (540) 387-1153

301 6th Street SW

PH: 540.342.7534

Roanoke, VA 24016

CONTACT INFORMATION:

Surveyor:

SHEET LIST

SHEET LIST


Sheet lumber	Sheet Title
C01	COVER SHEET
C02	GENERAL NOTES
C03	E&SC AND SWM NARRATIVE
C04	EXISTING CONDITIONS
C05	OVERALL SITE PLAN
C06	PHASE I & II DEMOLITION & INITIAL ESC PLAN
C07	PHASE I & II SITE DIMENSIONAL PLAN
C08	PHASE I & II UTILITY PLAN
C09	PHASE I & II GRADING & E&SC PLAN
C10	PHASE III & IV DEMOLITION & INITIAL ESC PLAN
C11	PHASE III & IV SITE DIMENSIONAL PLAN
C12	PHASE III & IV UTILITY PLAN
C13	PHASE III & IV GRADING & E&SC PLAN
C14	CIVIC SPACE EXHIBIT
C15	E&SC DETAILS
C16	SITE DETAILS
C17	STORM & SANITARY SEWER PROFILES
C18	WATER & SANITARY SEWER DETAILS
C19	STORM DETAILS
L01	LANDSCAPING PLAN
L02	LANDSCAPING DETAILS
1.02	LICHTING DI ANI

VICINITY MAP 1" = 5,000'

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C01	COVER SHEET
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C19	STORM DETAILS
L01	LANDSCAPING PLAN
L02	LANDSCAPING DETAILS
L03	LIGHTING PLAN

L04 LIGHTING DETAILS

PLAN LEGEND:

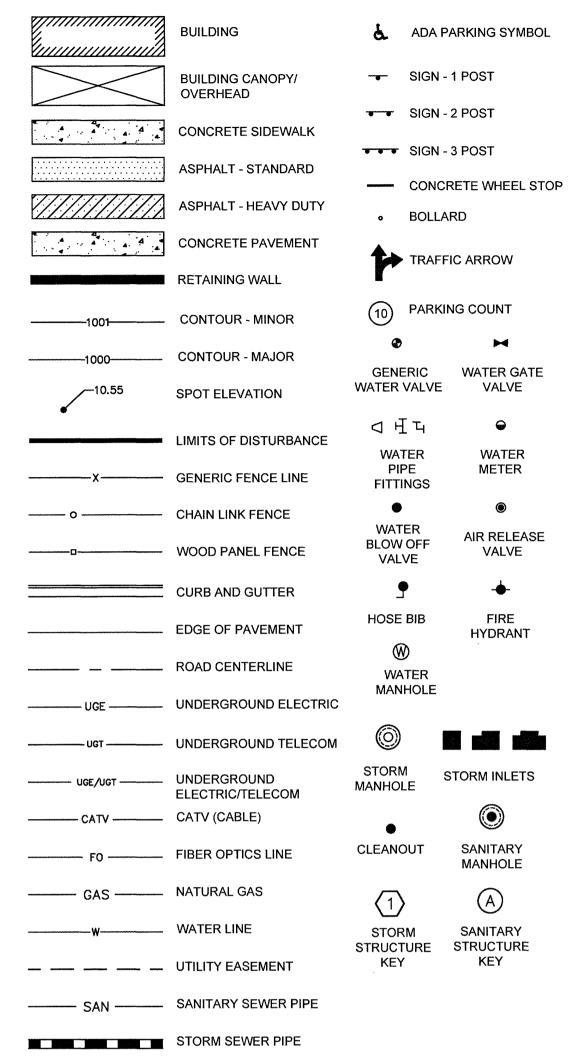

	REVIATIONS SYMBOLS	D.I. DI DIA. DS	DUCTILE IRON DROP INLET DIAMETER DOWNSPOUT
SYMBOLS		EA. E.F.	EACH EACH FACE
© • •	AT CENTERLINE PLATE DIAMETER DEGREE	ELEV. EX. EXP. E.W. FC	ELEVATION EXISTING EXPANSION EACH WAY FACE OF CURB
<u>ABBREVIATIONS</u>		FL FT	FINISHED FLOOR FLOW LINE FOOT (FEET)
A AC BC BLDG BOTT. BS BW. CF CG CII. CIP CJ CLR. C.O. CONC.	AREA ACRE(S) BACK OF CURB BUILDING BOTTOM BOTTOM OF STEP BOTTOM OF WALL CUBIC FEET CURB AND GUTTER CAST IRON CURB INLET CAST IN PLACE CONSTRUCTION JOINT CLEAR CLEANOUT CONCRETE	GA GALV. GS GV ID INV. JT. LAT LB LBS LF MAT'L. MAX. MFR. MH MIN. M.J.	GAUGE GALVANIZED GROUND SHOT GATE VALVE INSIDE DIAMETER INVERT JOINT LATERAL POUND POUNDS LINEAR FOOT (FE MATERIAL MAXIMUM MANUFACTURER MANHOLE MINIMUM MECHANICALLY JO
CONT. CY D.B.	CONTINUOUS CUBIC YARD(S) DEED BOOK	0.C. OD PB	ON CENTER OUTSIDE DIAMETE PLAT BOOK

11 Sewer- 6" National SDRZLe	
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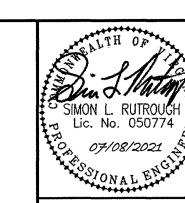
Contractor: Bowman Executing


Asbuilts-Brian Whitenach 11/19/2)

PROPERTY LINE POUNDS PER SQUARE INCH POINT OF TANGENCY POLYVINYL CHLORIDE REINFORCED CONCRETE RCP ROOF DRAIN REQ'D. REQUIRED RIGHT-OF-WAY SANITARY SEWER SQUARE FOOT (FEET) SPEC. SPECS SPECIFICATION SPECIFICATIONS SQUARE STORM STANDARD SIDEWALK STORM WATER MANAGEMENT SQUARE YARD(S) TURNED DOWN CURB TEMPORARY TOP OF STEP TOP OF WALL UNLESS NOTED OTHERWISE UNO VIRGINIA DEPARTMENT OF VIRGINIA EROSION AND SEDIMENT CONTROL HANDBOOK WATER VALVE WELDED WIRE FABRIC

SOSI

81 PSI




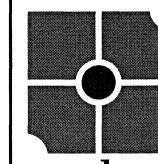

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R ONE FE UNION EVISION EDIT (ELD RETTENT)

THE STREET

OF ROANO

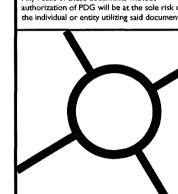CRI CRI FIE

REVISIONS IST REVIEW COMMENTS JANUARY 28, 2021 2ND REVIEW COMMENTS FEBRUARY 26, 2021 FIELD REVISION #1 JULY 08, 2021

PDG CEP / JMD

NOVEMBER 09, 2020

COVER SHEET

19-0135



VIRGINIA LAW REQUIRES CONTRACTOR TO CONTACT MISS UTILITY (811) IN ADVANCE OF PLANNED WORK.

ADVANCE TIME PERIOD SHALL BE AT LEAST 48 HOURS (www.missutilityofvirginia.com).

CONTACT THE CITY OF ROANOKE ENVIRONMENTAL REVIEWER, CITY CONSTRUCTION COORDINATOR, AND MISS UTILITY 48 HOURS IN ADVANCE OF ANY CONSTRUCTION ACTIVITY.