
QUANTITY AND COST ESTIMATE Quantity Unit Unit Price CLEARING AND GRUBBING ACRES EXCAVATION CY **EMBANKMENT** CY CURB INLET DI-EACH CURB INLET DI-EACH MANHOLE MH-EACH MANHOLE MH-EACH -IN. CONCRETE PIPE, CLASS III LF -IN. CONCRETE PIPE, CLASS IV LF -IN. C.M. CULVERT LF -IN. C.M. CULVERT LF BOX CULVERT LS PAVED DITCH LF RIPRAP-CLASS SF SODDED SWALE SY -IN. CONCRETE ENDWALL, EW-EACH -IN. END SECTION, ES-EACH DRIVEWAY, ENTRANCE TYPE EACH LF SIDEWALK, -FT. WIDE LF HEADER CURB & GUTTER, CG-CURB & GUTTER, CG-LF VALLEY GUTTER EACH PAVEMENT DESIGN CATEGORY SY CATEGORY SY STREET SIGNS EACH -IN. WATER LINE LF -IN. WATER LINE LF FIRE HYDRANT ASSEMBLIES EACH BLOW-OFFS w/VAULT, FRAME & COVER EACH -IN. GATE VALVES w/VAULT, FRAME & COVER EACH -IN. GATE VALVES w/VAULT, FRAME & COVER EACH SERVICE CONNECTIONS EACH MISCELLANEOUS FITTINGS EACH -IN. SANITARY SEWER LF -IN. SANITARY SEWER ST'D. MANHOLE w/FRAME & COVER EACH SERVICE CONNECTIONS w/CLEANOUTS EACH AS-BUILT PLANS SUBTOTAL CONTINGENCY ESTIMATED TOTAL I hereby certify that the foregoing estimate reflects the current improvements of this project. SIGNED:

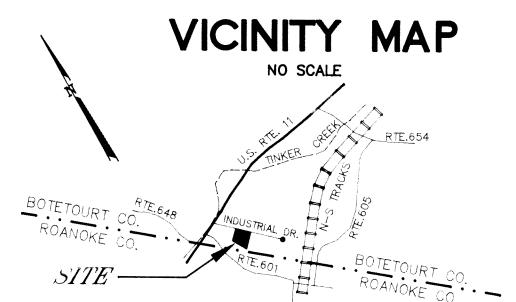

ENGINEER'S NOTES

T.P. PARKER & SON ASSUMES NO RESPONSIBILITY FOR ADEQUACY OF PLANS OR FOR INFORMATION ON PLANS UNTIL SUCH PLANS HAVE BEEN APPROVED BY THE REQUIRED PUBLIC AGENCIES.

ANY WORK COMMENCED ON A PROJECT PRIOR TO PLAN APPROVAL IS AT SOLF RISK OF THE DEVELOPER.

T.P. PARKER & SON DOES NOT GUARANTEE THE COMPLETION OR QUALITY OF PERFORMANCE OF THE CONTRACTS OR THE COMPLETION OR QUALITY OF PERFORMANCE OF CONTRACTS BY SUBCONTRACTORS OR OTHER THIRD PARTIES.

SOURCE OF TOPOGRAPHIC MAPPING IS T.P. PARKER & SON DATED APRIL, 1992

BOUNDARY SURVEY WAS PERFORMED BY T.P. PARKER & SON DATED APRIL, 1992

VDOT NOTES

ALL NECESSARY UTILITY LATERALS WILL BE PLACED PRIOR TO PAVEMENT SURFACING, OR CONDUIT PROVISIONS BE MADE FOR THE SAME (i.e. WATER, SEWER, GAS AND TELEPHONE.)

CARE MUST BE TAKEN DURING CONSTRUCTION TO PREVENT EROSION, DUST, AND MUD FROM DAMAGING ADJACENT PROPERTY, CLOGGING DITCHES, TRACKING PUBLIC STREETS, AND OTHERWISE CREATING A PUBLIC OR PRIVATE NUISANCE TO SURROUNDING AREAS.

IF EROSION IS ENCOUNTERED IN ANY DRAINAGE EASEMENT, IT WILL BE THE RESPONSIBILITY OF THE DEVELOPER TO SOD, RIP-RAP, GROUT, PAVE, OR TO DO WHATEVER IS NECESSARY TO CORRECT THE PROBLEM.

MINIMUM PAVEMENT RADIUS OF 25 FEET REQUIRED AT ALL STREET INTERSECTIONS.

WHILE THESE PLANS HAVE BEEN APPROVED, SUCH APPROVAL DOES NOT EXEMPT CONNECTIONS WITH EXISTING STATE MAINTAINED ROADS FROM CRITICAL REVIEW AT THE TIME PERMIT APPLICATIONS ARE MADE. THIS IS NECESSARY IN ORDER THAT THE PREVAILING CONDITIONS ARE TAKEN INTO CONSIDERATION REGARDING SAFETY REQUIREMENTS. ADDITIONAL SAFETY ACCOMPANIMENTS SUCH AS TURNING LANES MAY OR MAY NOT BE REQUIRED.

SEWER NOTES

A MINIMUM COVER OF THREE (3) FEET IS REQUIRED OVER PROPOSED LINES.

CONTRACTOR SHALL BE RESPONSIBLE FOR LOCATING AND UNCOVERING ALL MANHOLES AFTER PAVING. MANHOLE TOPS SHALL BE ADJUSTED TO GRADE IF NECESSARY.

ALL EXISTING UTILITIES MAY NOT BE SHOWN, OR MAY NOT BE SHOWN IN THE EXACT LOCATION. THE CONTRACTOR SHALL COMPLY WITH STATE WATER WORKS REGULATIONS, SECTION 12.05.03, WHERE LINES CROSS.

HOUSE CONNECTIONS ARE TO BE MADE WITH 4" PIPE INSTALLED ON A MINIMUM 20 . F 1 /4 INCH TO 1 FOOT IN THE RIGHT OF WAY.

LATERALS FROM MANHOLES SHALL BE P.V.C. OR DUCTILE IRON OF SUFFICIENT LENGTH TO PROVIDE TWO (2) FEET OF BEARING ON NATURAL GROUND. ANY TRANSITION FROM DUCTILE IRON SHALL BE MADE WITH AN ADAPTOR COUPLING.

ALL TRENCHES SHALL BE COMPACTED ACCORDING TO VDOT STANDARDS. LINES SHALL BE STAKED PRIOR TO CONSTRUCTION.

WATER NOTES

A MINIMUM COVER OF THREE (3) FEET IS REQUIRED OVER PROPOSED LINES.

CONTRACTOR SHALL BE RESPONSIBLE FOR LOCATING AND UNCOVERING VALVE VAULTS AFTER PAVING AND ADJUSTMENT TO FINAL GRADE IF NECESSARY.

ALL EXISTING UTILITIES MAY NOT BE SHOWN, OR MAY NOT BE SHOWN IN THE EXACT LOCATION. THE CONTRACTOR SHALL COMPLY WITH STATE WATER WORKS REGULATIONS, SECTION 12.05.03, WHERE LINES CROSS.

ALL TRENCHES SHALL BE COMPACTED ACCORDING TO _______STANDARDS. LINES SHALL BE STAKED PRIOR TO CONSTRUCTION.

WATER LINE SHALL BE MINIMUM CLASS _50 DUCTILE IRON IN ACCORDANCE TO AWWA C151 OR SDR14 PVC IN ACCORDANCE TO C-900.

GENERAL NOTES

ALL CONSTRUCTION METHODS AND MATERIALS SHALL CONFORM TO THE CONSTRUCTION STANDARDS AND SPECIFICATIONS OF BOT. CO. AND/OR THE VIRGINIA DEPARTMENT OF TRANSPORTATION.

THE CONTRACTOR OR DEVELOPER IS REQUIRED TO NOTIFY THE ENGINEERING DIVISION IN WRITING AT LEAST THREE (3) DAYS PRIOR TO ANY CONSTRUCTION, INCLUDING BUT NOT LIMITED TO THE FOLLOWING:

A. INSTALLATION OF APPROVED EROSION CONTROL DEVICES.

B. CLEARING AND GRUBBING.

C. SUBGRADE EXCAVATION. D. INSTALLING STORM SEWERS OR CULVERTS.

E. INSTALLING CURB AND GUTTER FORMS. F. PLACING CURB AND GUTTER.

G. PLACING OTHER CONCRETE.

H. PLACING GRAVEL BASE. I. PLACING ANY ROADWAY SURFACE.

J. INSTALLING WATER LINES. K. INSTALLING SANITARY SEWER LINES.

A PRECONSTRUCTION CONFERENCE SHOULD BE SCHEDULED WITH THE BOT. CO. ENGINEERING DIVISION, TO BE HELD AT LEAST ONE DAY PRIOR TO ANY CONSTRUCTION.

MEASURES TO CONTROL EROSION AND SILTATION MUST BE PROVIDED FOR PRIOR TO PLAN APPROVAL. PLAN APPROVAL IN NO WAY RELIEVES THE DEVELOPER OR CONTRACTOR OF THE RESPONSIBILITIES CONTAINED IN

EROSION AND SILTATION CONTROL POLICIES. A PERMIT MUST BE OBTAINED FROM THE VDOT RESIDENCY OFFICE, SALEM PRIOR TO CONSTRUCTION IN THE HIGHWAY RIGHT OF WAY.

PLAN APPROVAL DOES NOT GUARANTEE THE ISSUANCE OF ANY PERMITS BY VDOT. AN APPROVED SET OF PLANS AND ALL PERMITS MU * BE AVAILABLE AT THE CONSTRUCTION SITE.

FIELD CONSTRUCTION SHALL HONOR PROPOSED DRAINAGE DIVIDES AS SHOWN

CONTRACTOR SHALL VERIFY AND BE RESPONSIBLE FOR ALL DIMENSIONS AT THE JOB SITE.

CONSTRUCTION DEBRIS SHALL BE CONTAINED IN ACCORDANCE WITH THE VIRGINIA LITTER CONTROL ACT. NO LESS THAN ONE LITTER RECEPTACLE SHALL BE PROVIDED ON-SITE.

THE CONTRACTOR SHALL PROVIDE ADEQUATE MEANS OF CLEANING MUD FROM TRUCKS AND/OR OTHER EQUIPMENT PRIOR TO ENTERING PUBLIC STREETS. IT IS THE CONTRACTOR'S RESPONSIBILITY TO INSURE THAT THE STREETS ARE IN A CLEAN, MUD AND DUST FREE CONDITION AT ALL TIMES.

THE DEVELOPER AND/OR CONTRACTOR SHALL SUPPLY ALL UTILITY COMPANIES WITH COPIES OF APPROVED PLANS, ADVISING THEN THAT ALL GRADING AND INSTALLATION SHALL CONFORM TO APPROVED PLANS.

CONTRACTORS SHALL NOTIFY UTILITIES OF PROPOSED CONSTRUCTION AT LEAST TWO, BUT NOT MORE THAN TEN WORKING DAYS IN ADVANCE. AREA PUBLIC UTILITIES MAY BE NOTIFIED THROUGH MISS UTILITY AT (800) 552-7001.

ALL WORK SHALL BE SUBJECT TO INSPECTION BY BOT. CO. AND/OR VDOT INSPECTORS.

FIELD CORRECTIONS SHALL BE APPROVED BY THE ENGINEERING DIVISION PRIOR TO SUCH CONSTRUCTION.

GRADE STAKES SHALL BE SET FOR ALL CURB AND GUTTER, CULVERT, SANITARY SEWER, AND STORM SEWER.

LOCATION OF UNDERGROUND UTILITIES IS BASED ON FIELD SURVEYS, AS SHOWN BY AVAILABLE RECORDS, AND AS LOCATED BY THE UTILITY LOCATOR SERVICE. CONTRACTOR SHALL VERIFY LOCATION OF ALL UTILITIES PRIOR TO

THE SITE WORK AND LANDS JAPING CONTRACTOR(S) SHALL COMPLY WITH LOCAL CODES IN OBSERVING EROSEN CONTROL MEASURES, BOTH ON AND OFF THE STE. REFER TO THE VIRENIA UNIFORM CODING SYSTEM CONTAINED IN THE VIRGINIA SCIL ERCISION AND SELIMENT CONTROL HANDBOOK, LATEST EDITION. FOR DETAILS AND SPECIFICATIONS OF EROSON CONTROL ITEMS SHOWN ON THESE PLANS.

ALL STORM DRAIN CONSTRUCTION SHALL BE IN CONFORMANCE WITH THE VIRGINIA DEFARTMENT OF TRANSPORTATION STANDARDS AND SPECIFICATIONS.

Appended for Sanney Sewer Construction of Construction TO Right Sanney Sense

Designed By: CLW

Orawn By: CLW

Date: <u>4-28-92</u>

W.O. # <u>92-0490</u>

Approved FOR 15/15 Review 6/16/92

SHEET

SHEET INDEX TITLE

TOTAL # SHEETS: TOTAL # SHEETS: A/E FIRM: # OF SETS:

TITLE SHEET DIMENSIONAL AND LANDSCAPING PLAN GRADING, UTILITIES, AND EROSION CONTROL PLAN GENERAL DETAILS SOIL EROSION & SEDIMENTATION CONTROL DETAILS

SYMBOLS ABBREVIATIONS ARROW HEAD TOP OF 100.5 E 100.5 SPOT ELEVATION MINIMUM FIRE HYDRANT MONUMENT ---- 100 ----100 CONTOURS APPROXIMATE NORTH BOUND LANE ASPH ASPHALT PROPOSED SANITARY SEWER LINE BOTTOM OF CURB PUBLIC UTILITY EASEMENT PUE WATERLINE BITUMINOUS PAVEMENT BLDG BUILDING BLOCK RIGHT — 2"G — GAS LINE BENCHMARK RIGHT OF WAY BOTTOM OF WALL REQD REQUIRED OVERHEAD ELECTRIC LINE CINDER BLOCK RAILROAD OVERHEAD TELEPHONE LINE CURB & GUTTER REAR YARD SETBACK CORRUGATED METAL PIPE CATV — OVERHEAD CABLE TELEVISION LINE SAN SANITARY CONCRETE SOUTH BOUND LANE UNDERGROUND TEL OR ELEC LINE STORM DRAIN DOUBLE SECT SECTION WATER OR GAS METER DEFLECTION SLOPE EASEMENT DROP INLET SANITARY SEWER DIAMETER FIRE HYDRANT SSE SANITARY SEWER EASEMENT DRAINAGE EASEMENT STA STATION ----MANHOLE EAST BOUND LINE STD STANDARD ELEC ELECTRIC ----O C.O. STORAGE ELEVATION SIDE YARD SETBACK DROP INLET (CURB OR GRATE) ENTRANCE TEMPORARY BENCHMARK EDGE OF PAVEMENT UTILITY POLE, GUY & ANCHOR TOP OF CURB ENDWALL TELEPHONE DITCH OR SWALE EXIST EXISTING TRANSFORMER FDN FOUNDATION CENTERLINE OR BASELINE TOP OF WALL FINISHED FLOOR TYPICAL PROPERTY LINE HIGH POINT VDOT VIRGINIA DEPARTMENT OF TRANSPORTATION SURVEY TRAVERSE POINT IRON PIN VERTICAL DEFLECTION ANGLE WEST BOUND LANE MINIMUM BUILDING LINE DIRECT ANGLE MANHOLE O Y.L. YARD LIGHTING YARD HYDRANT BENCHMARK FENCE TREE LINE RAILROAD HANDICAPPED SPACE

LEGEND

NAME OF PRECISION HYDRAULICS DEVELOPMENT

LOCATION

LOT 2 - BOTETOURT INDUSTRIAL PARK INDUSTRIAL DRIVE COUNTY OF BOTETOURT, VIRGINIA

OWNER

STEVE CRAFT & JAMES BUSSEY 5637 WILLIAMSON RD.

ROANOKE, VIRGINIA, 24012

PHONE: (703) 366-0229

DEVELOPER


SAME AS OWNER


TAX MAP #(S) 106C

BLOCK #(S)_

PARCEL #(S)___2

REVISIONS No. Date Remarks Ву PER VDOT REVIEW CLW PER BOTETOURT COUNTY REVIEW CLW FRANK B. CALDWELL, III 🏲

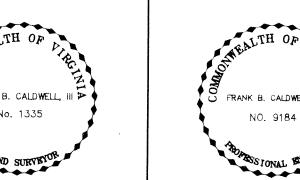


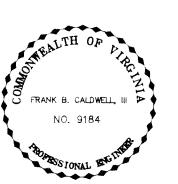



TPP&S · ENGINEERS SURVEYORS PLANNERS

T. P. PARKER & SON

816 Boulevard Post Office Box 39 Salem, Virginia 24153 Telephone: 703-387-1153 FAX: 703-389-5767

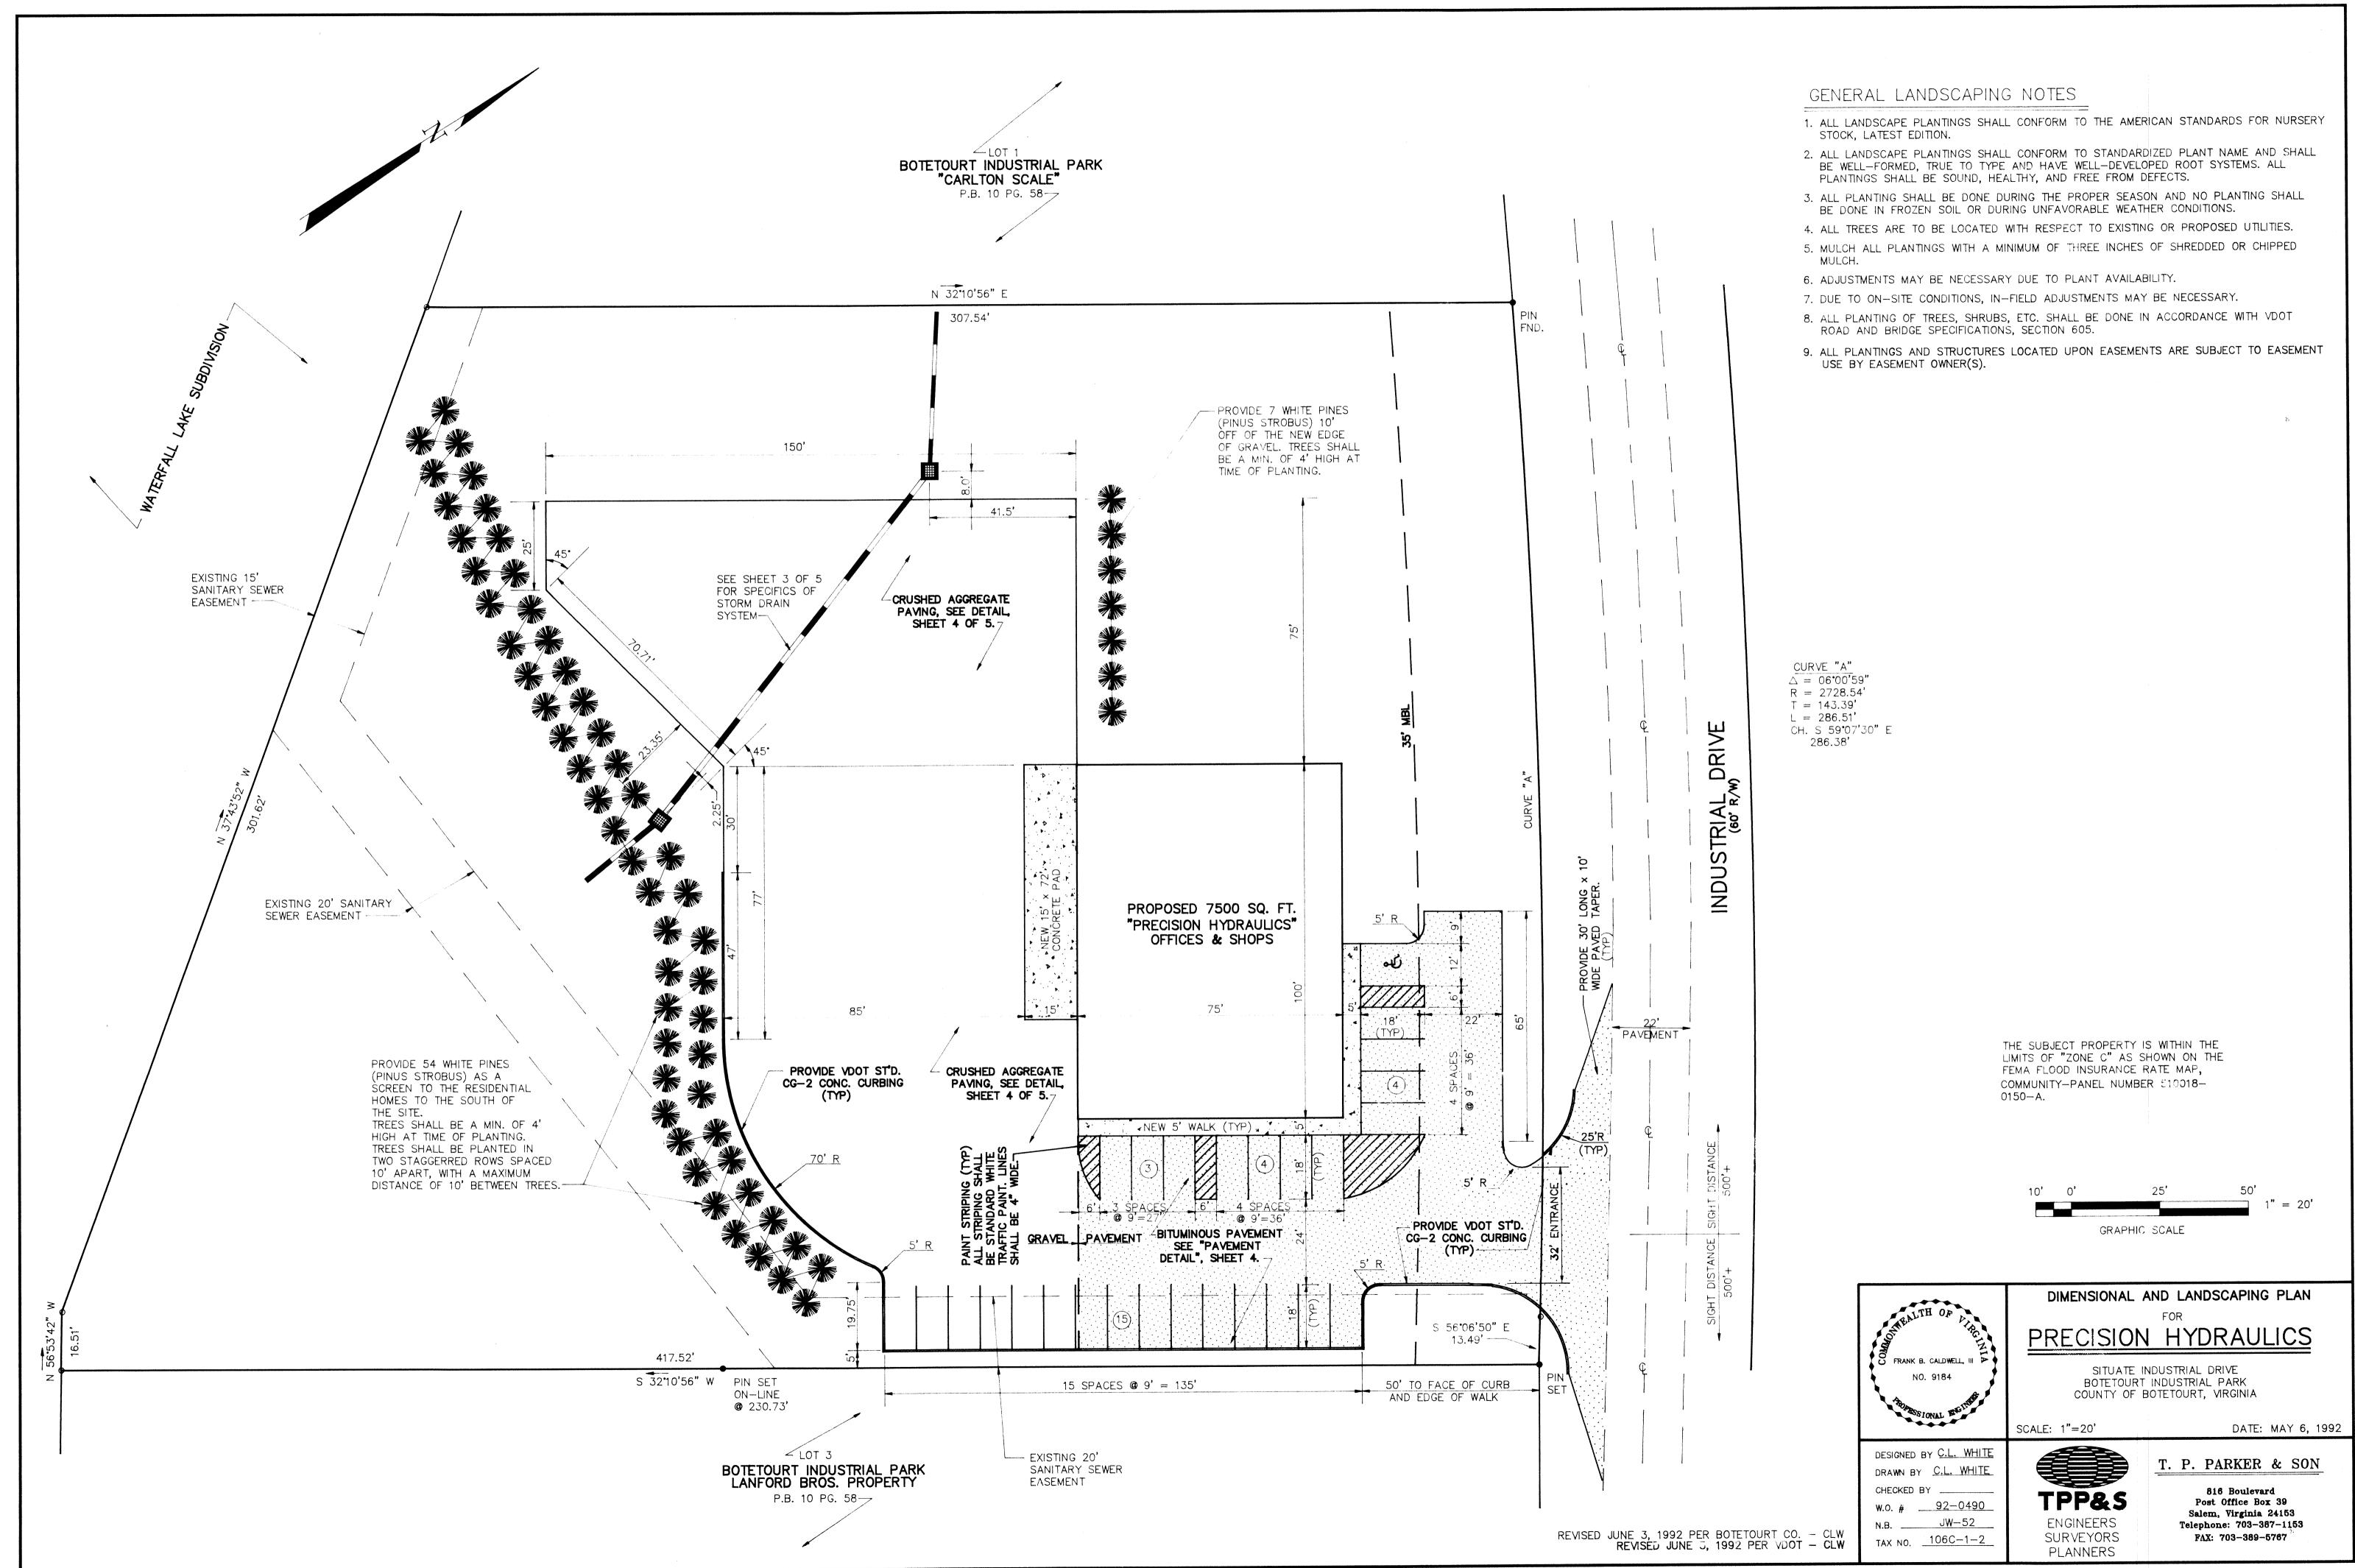

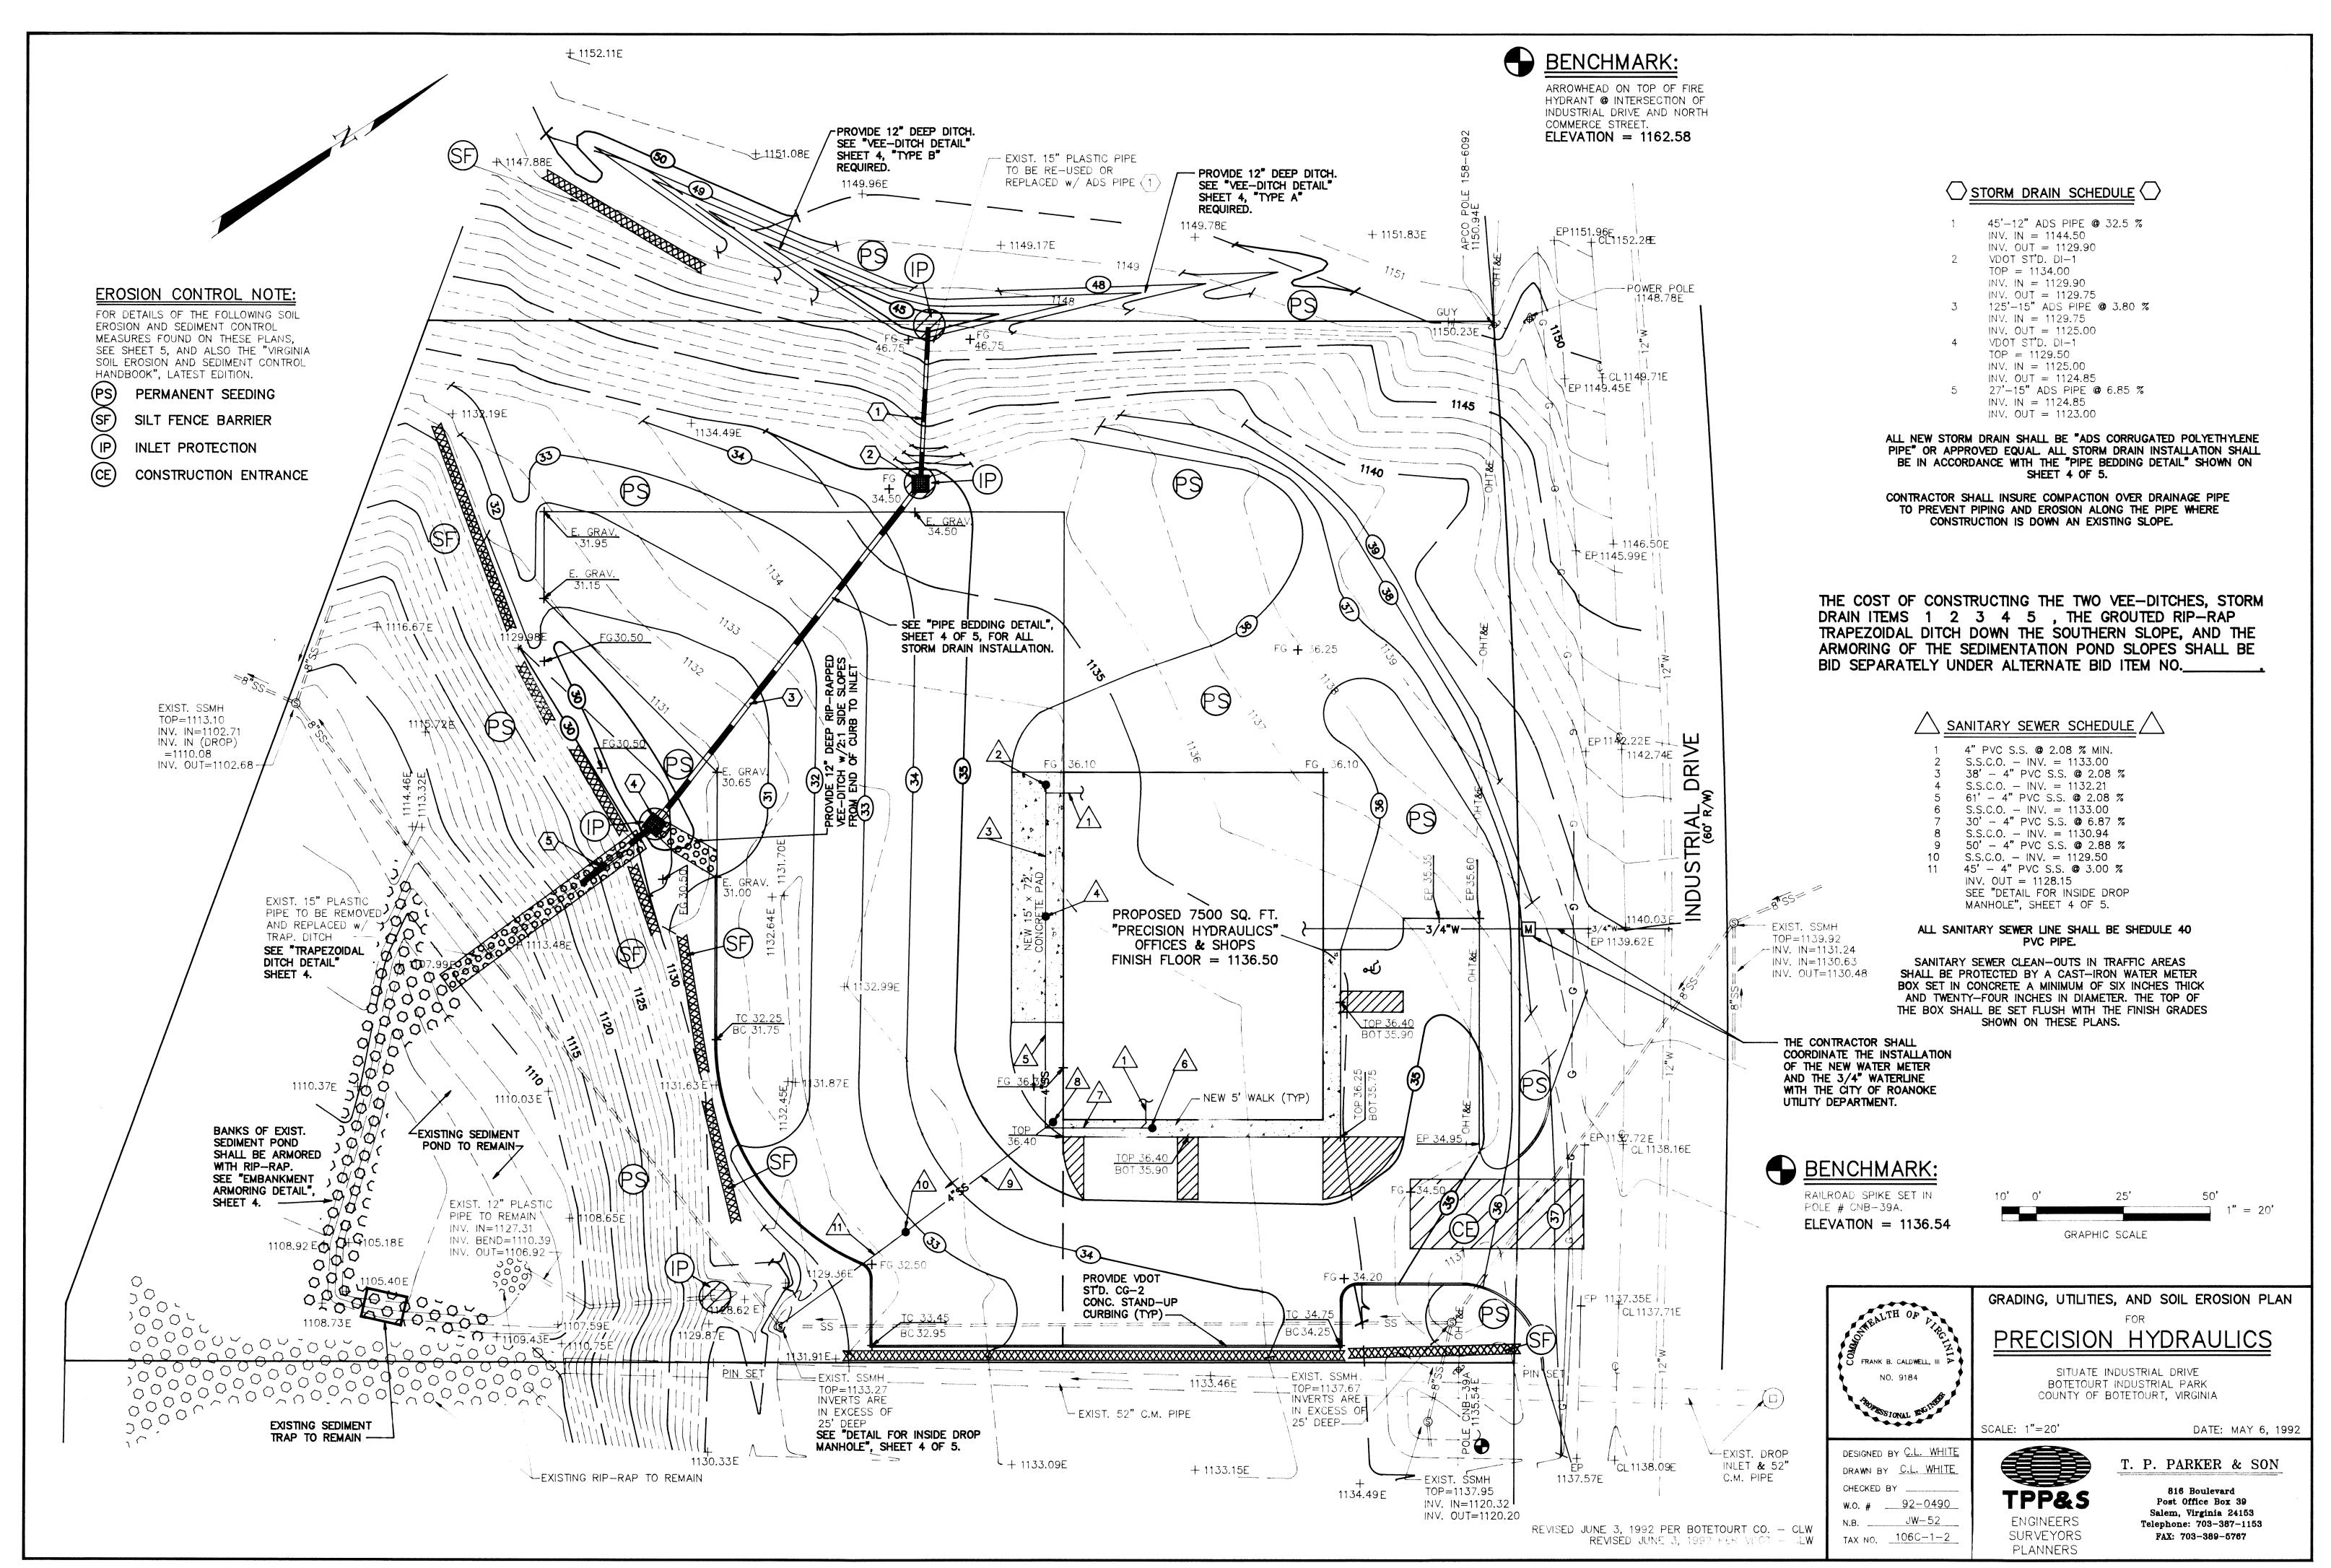

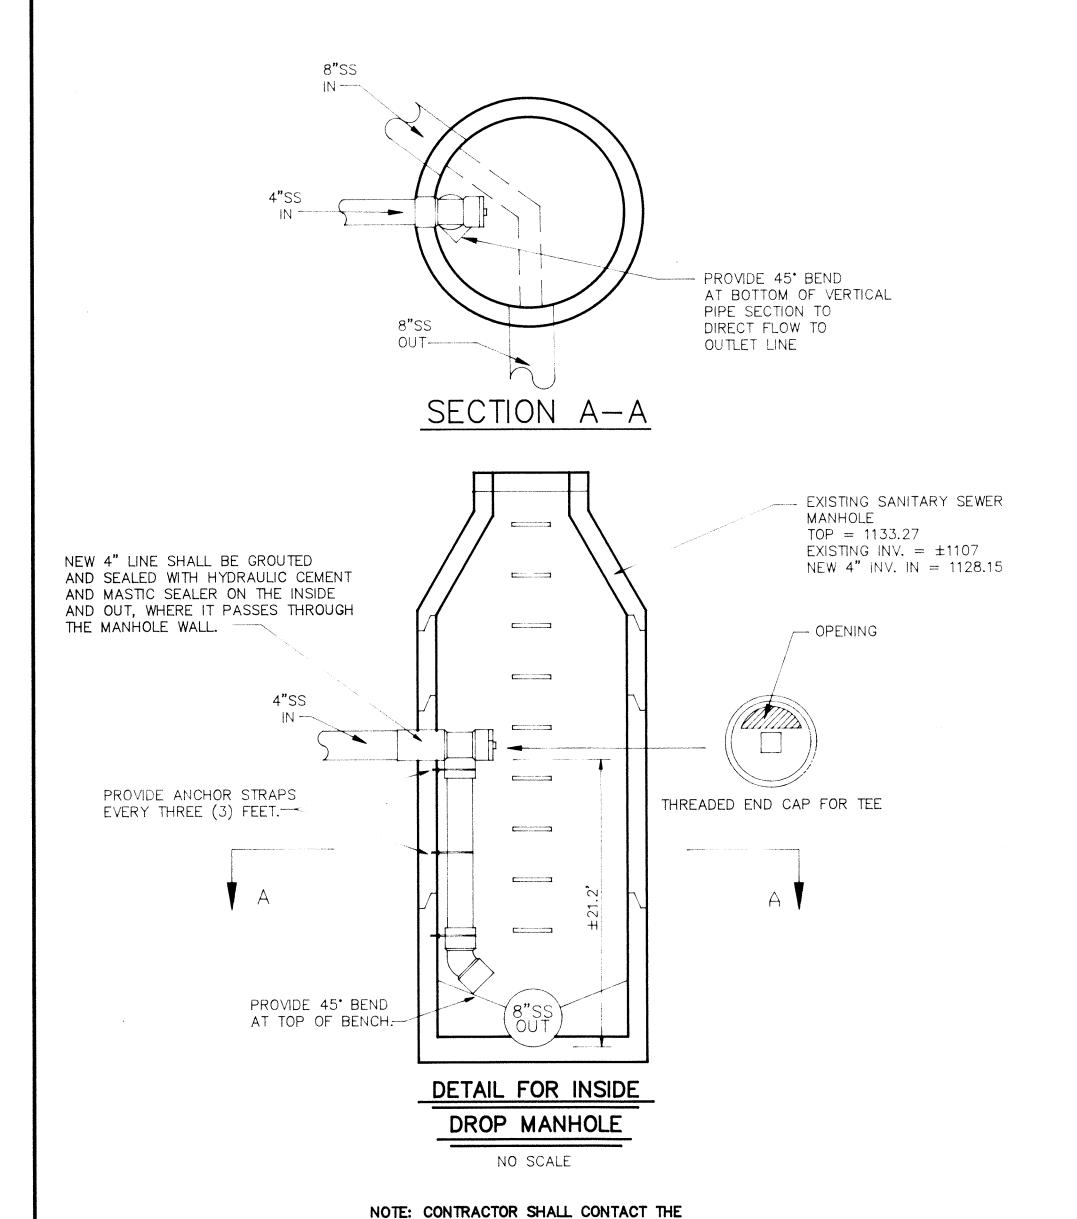

BOTETOURT COUNTY DEPT. OF PUBLIC

WORKS (703) 992-8316 TO INSPECT THE CONSTRUCTION OF THE LATERAL-TO-MANHOLE JOINT PRIOR TO BACKFILLING AGAINST THE MANHOLE.

- 8" OF CRUSHER-RUN AGGREGATE

- COMPACTED SUBGRADE

--- SUBGRADE AND AGGREGATE SHALL BE LAID AND COMPACTED TO 90 % OF STANDARD PROCTOR USING A VIBRATORY ROLLER OR SIMILAR APPROVED COMPACTION EQUIPMENT


CRUSHED AGGREGATE

PAVING DETAIL

NO SCALE

ALL COMPACTION AND PAVING OPERATIONS SHALL CONFORM TO VDOT STANDARDS AND SPECIFICATIONS


> ___ 2" TYPE SM-2A BITUMINOUS CONCRETE WEAR COURSE 8" TYPE 21-B AGGREGATE BASE MATERIAL -

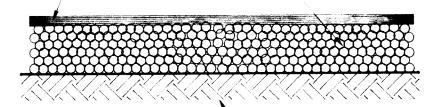

- COMPACTED SUBGRADE

BITUMINOUS PAVEMENT DETAIL

NO SCALE

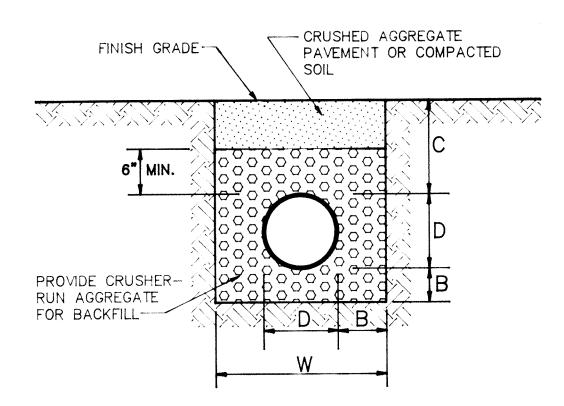


MINIMUM DIMENSIONS TRENCH INSTALLATION

NOMINAL DIAMETER	MINIMUM THICKNESS	MINIMUM COVER	MIN. TRENCH WIDTH
D	В	С	W
10"	4"	12"	20"
12"	5 "	12"	24"
15"	5 "	12"	2 8"
18"	6"	12"	36 "
24"	6"	12"	42"


- 1. CRUSHER-RUN AGGREGATE SHOULD BE USED AS THE BEDDING AND ENVELOPE MATERIAL AROUND THE
- 2. THE CORRUGATED PIPE SHOULD BE LAID ON GRADE, ON A LAYER OF BEDDING MATERIAL AS SHOWN. THE BACKFILL MATERIAL SHOULD BE WELL COMPACTED IN SIX INCH LAYERS UNDER THE HAUNCHES, AROUND THE SIDES, AND ABOVE THE PIPE TO THE FINISH GRADE ELEVATION SHOWN ON THE PLANS.

PIPE BEDDING DETAIL NO SCALE

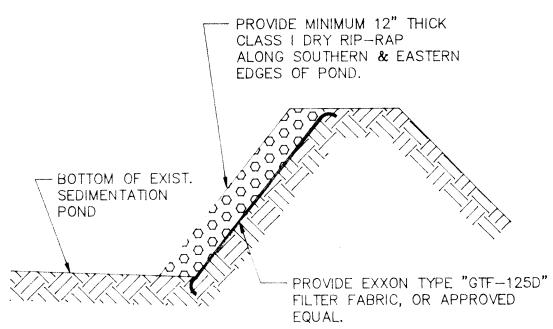

EMBANKMENT ARMORING DETAIL


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TRAPEZOIDAL DITCH SECTION

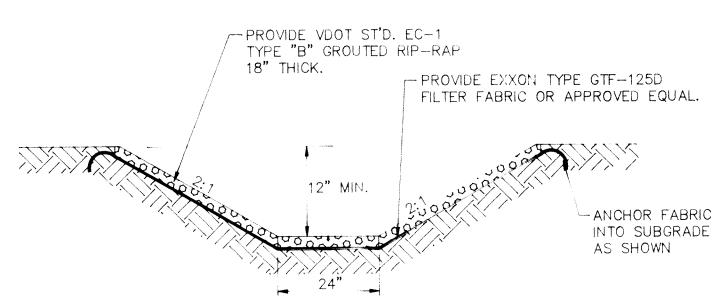
NO SCALE

TRAPEZOIDAL DITCH SHALL EXTEND FROM THE TOP OF SLOPE TO THE BOTTOM OF THE EXISTING SEDIMENT POND AS SHOWN ON SHEET 3 OF 5.



VEE-DITCH DETAIL

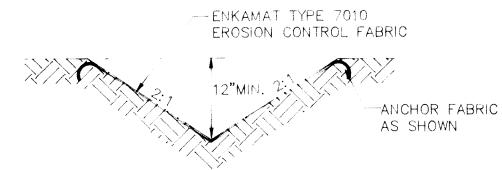"TYPE A" - EARTH ONLY, ENKAMAT NOT REQUIRED "TYPE B" - ENKAMAT REQUIRED TO FULL DEPTH

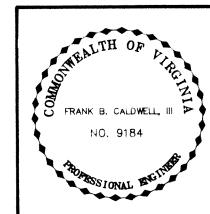

TAX NO. 106C-1-2

GENERAL DETAILS

PRECISION HYDRAULICS

SITUATE INDUSTRIAL DRIVE BOTETOURT INDUSTRIAL PARK COUNTY OF BOTETOURT, VIRGINIA

SCALE: AS SHOWN DESIGNED BY C.L. WHITE DRAWN BY C.L. WHITE CHECKED BY w.o. # 92-0490 JW-52

ENGINEERS SURVEYORS PLANNERS

T. P. PARKER & SON 816 Boulevard Post Office Box 39


Salem, Virginia 24153


Telephone: 703-387-1153


FAX: 703-389-5767


DATE: MAY 6, 1992


REVISED JUNE 3, 1992 PER BOTETOURT CO. — CLW REVISED JUNE 3, 1992 PER VDOT — CLW

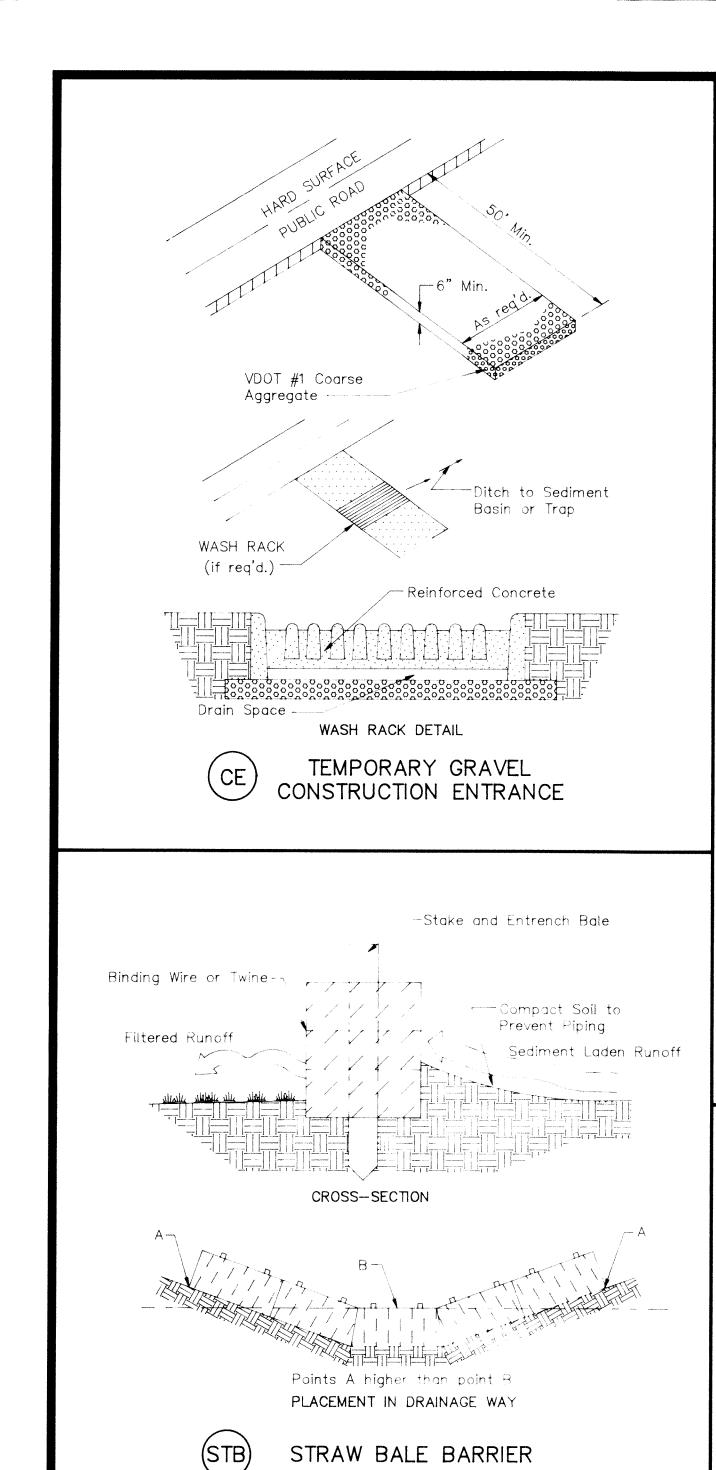


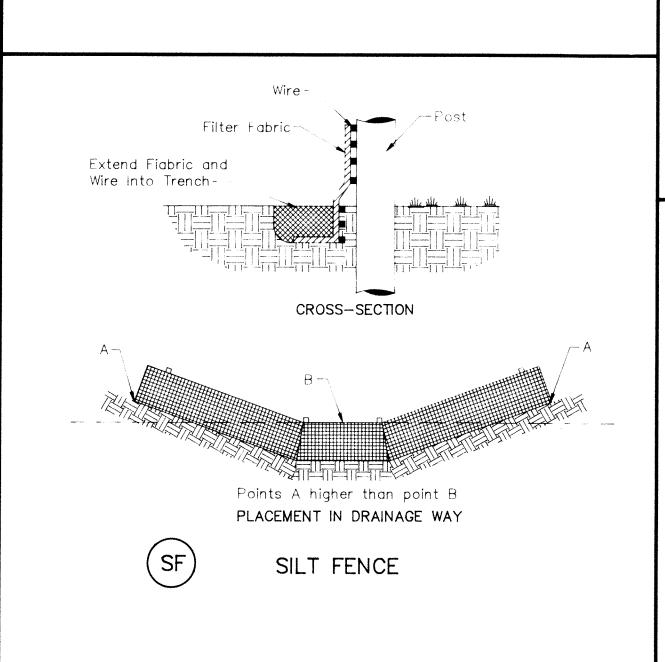


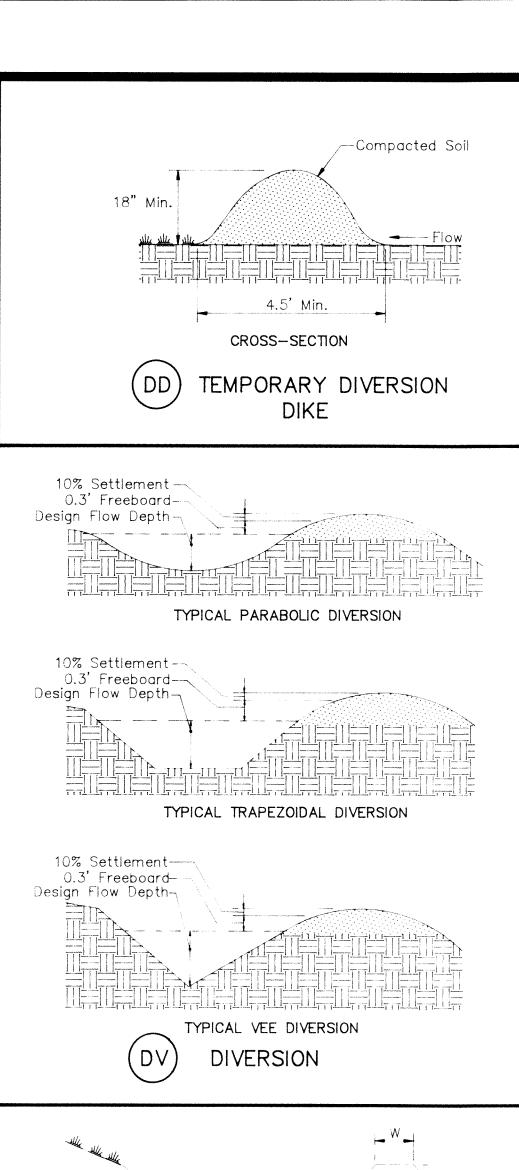


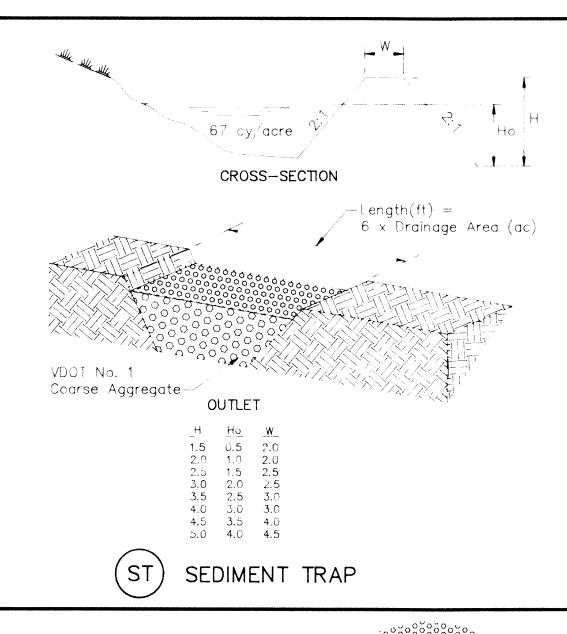


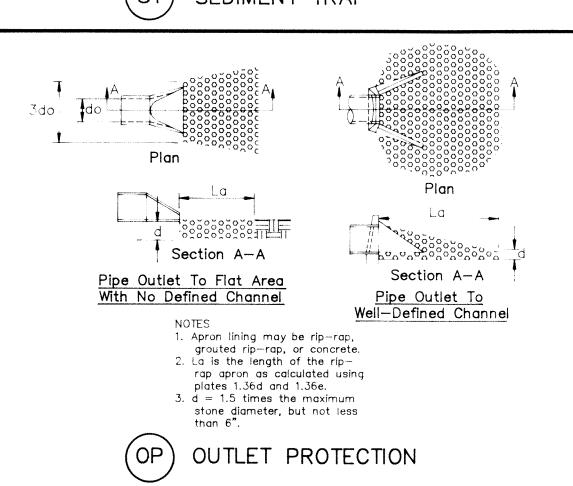

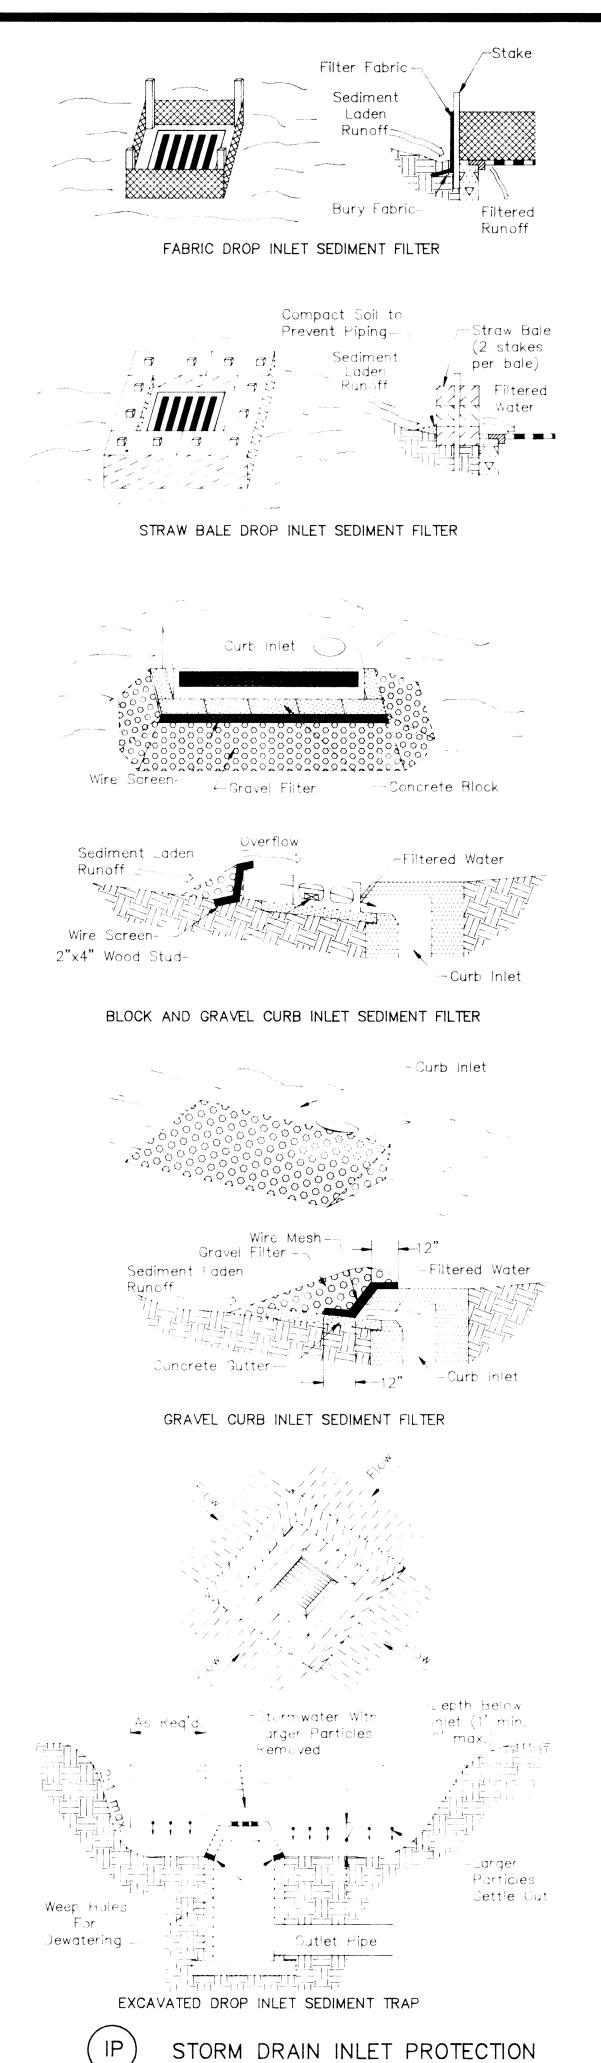

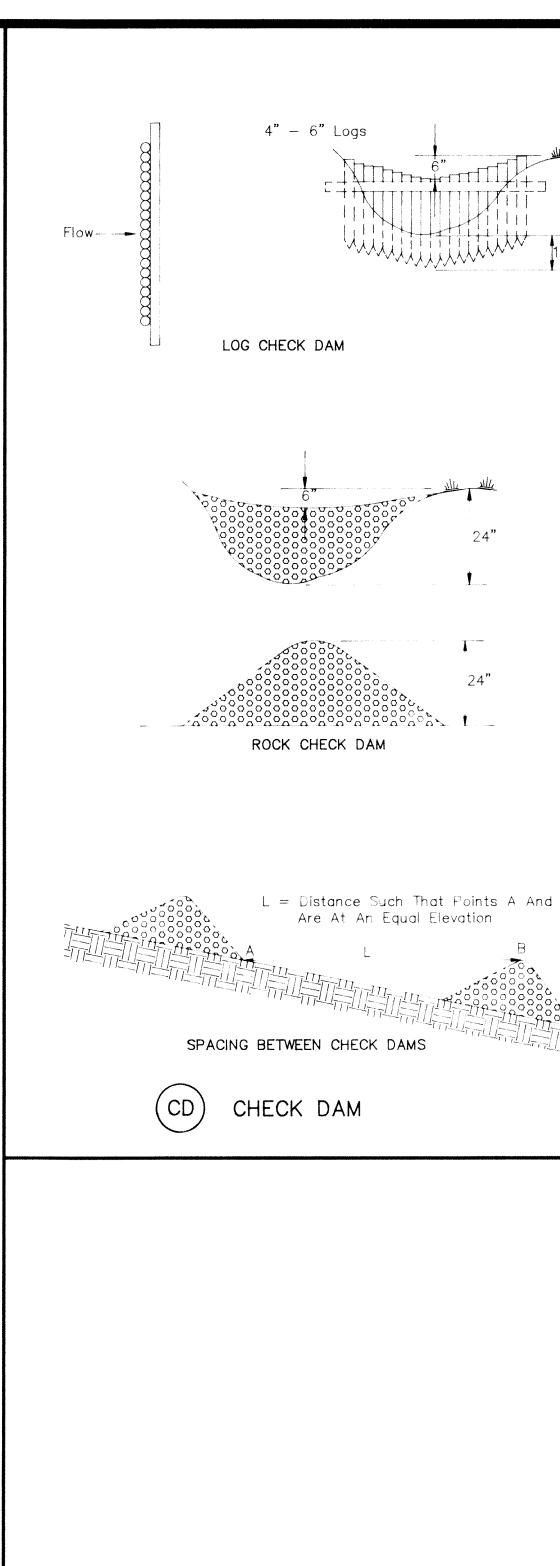

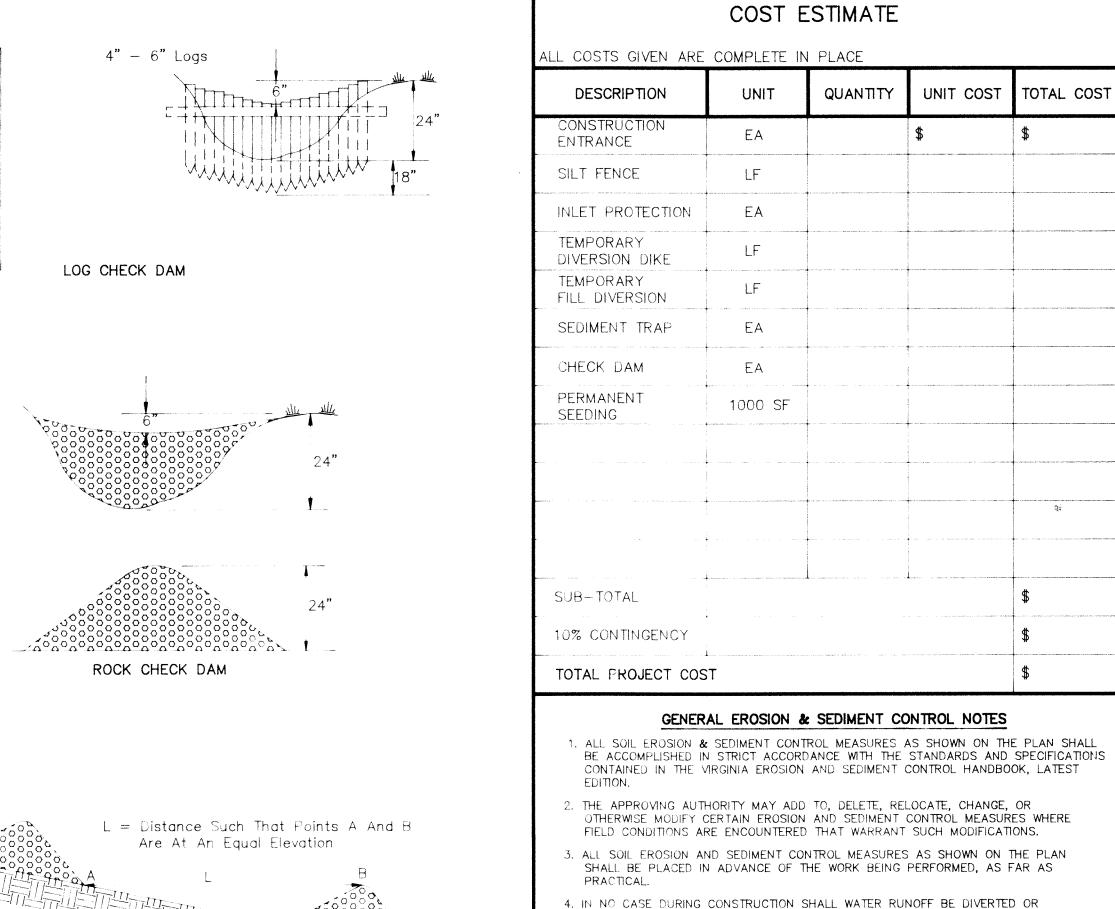

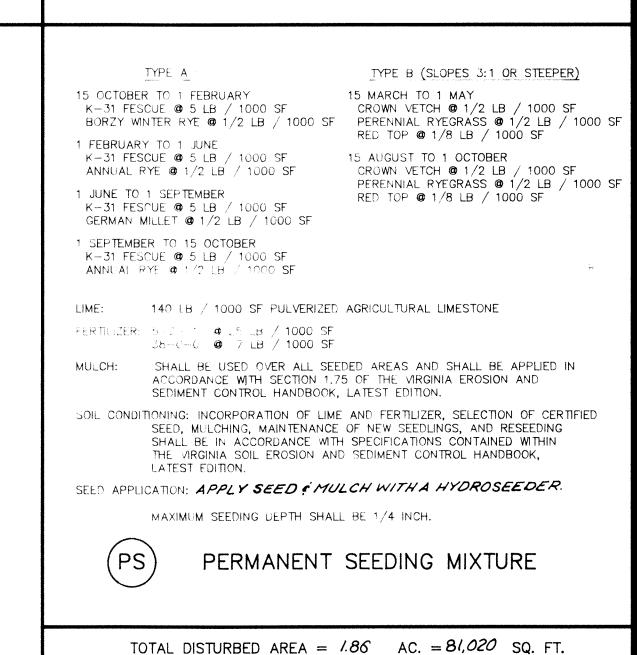

ALLOWED TO FLOW TO LOCATIONS WHERE ADEQUATE PROTECTION HAS NOT BEEN

5. IT SHALL BE THE CONTRACTOR'S RESPONSIBILITY TO LEAVE THE SITE ADEQUATELY PROTECTED AGAINST EROSION, SEDIMENTATION, OR ANY DAMAGE TO ANY ADJACENT

6. FOR THE EROSION CONTROL KEY SYMBOLS SHOWN ON THE PLANS, REFER TO THE

CONTAINED IN THE VIRGINIA EROSION AND SEDIMENT CONTROL HANDBOOK,

VIRGINIA UNIFORM CODING SYSTEM FOR EROSION AND SEDIMENT CONTROL PRACTICES

PROPERTY AT THE END OF EACH DAY'S WORK.

LATEST EDITION.

DESIGNED BY CLW

DRAWN BY ___(CADD)

w.o. # 92-0490

TAX NO. 106C-1-2

JW-52

CHECKED BY

N.B. ___

EROSION-SILTATION CONTROL

EROSION AND SILTATION CONTROL DETAILS

PRECISION HYDRAULICS

LOT 2 - BOTETOURT INDUSTRIAL PARK COUNTY OF BOTETOURT, VIRGINIA



NO SCALE