ROANOKE/FRANKLIN COUNTY WATERLINE EXTENSION PHASE I-A

CAVE SPRING MAGISTERIAL DISTRICT ROANOKE COUNTY, VIRGINIA

AUGUST 12, 2008 PROJECT #FCPP1004

GENERAL SITE PLAN NOTES

- CLIENT: WESTERN VIRGINIA WATER AUTHORITY
- CONTACT INFORMATION: EARTH ENVIRONMENTAL CONSULTANTS, INC.
- 3. PARCEL INFORMATION: MULTIPLE PARCELS IDENTIFIED IN PLANS
- THE CONTRACTOR SHALL ASSEMBLE AND INSTALL MATERIALS/PRODUCTS IN STRICT ACCORDANCE WITH THE MANUFACTURER'S RECOMMENDATIONS AND INDUSTRIAL/ASSOCIATION STANDARDS.
- SEE SPECIFICATIONS FOR SPECIFIC DETAILS RELATED TO WATERLINE AND APPURTENANCES.
- THE PROPERTY OWNER AND/OR CONTRACTOR IS RESPONSIBLE FOR OBTAINING EROSION AND SEDIMENT CONTROL PERMIT AND PERMISSION FOR ANY OFFSITE GRADING, EROSION & SEDIMENT CONTROL MEASURES, AND CONSTRUCTION.
- NO GRADING IS PERMITTED PRIOR TO INSTALLATION OF EROSION & SEDIMENT CONTROL MEASURES AND ISSUANCE OF A LAND DISTURBANCE PERMIT BY THE APPROPRIATE REVIEWING AUTHORITY.
- CONTRACTOR SHALL INSTALL & MAINTAIN ADDITIONAL EROSION & SEDIMENT CONTROL DEVICES, PER THE LATEST EDITION OF THE
- CONTRACTOR SHALL ENSURE THAT ANY OFF SITE WORK SUCH AS LAND FILLING OPERATIONS SHALL BE PRE APPROVED BY THE OFF SITE PROPERTY OWNER ACCEPTING THE MATERIAL AND THE APPROPRIATE PERMITTING AUTHORITY.
- 10. UTILITIES SHOWN HEREON ARE BASED ON AVAILABLE ABOVE GROUND STRUCTURES (VALVES, POLES, MANHOLES, ETC.)
- 11. IT IS THE CONTRACTOR'S RESPONSIBILITY TO MEET COMPLIANCE REQUIREMENTS WITH SECTION 59.1-406, ET SEQ. OF THE CODE OF VIRGINIA (OVERHEAD HIGH VOLTAGE LINES SAFETY ACT).
- 12. CONTRACTOR SHALL BE RESPONSIBLE FOR REPAIR OF ANY DAMAGES AS A RESULT OF CONSTRUCTION ACTIVITIES.
- . THE CONTRACTOR SHALL FIELD VERIFY THE HORIZONTAL AND VERTICAL ALIGNMENT OF ALL UTILITIES PRIOR TO CONSTRUCTION. THE CONTRACTOR SHALL CONTACT MISS UTILITY AT LEAST 72 HOURS PRIOR TO COMMENCEMENT OF ANY CONSTRUCTION ACTIVITY
- 4. CONTRACTOR SHALL USE TRAFFIC CONTROL FLAGGERS ON PUBLIC ROADS. CONTRACTOR IS RESPONSIBLE FOR MEETING THE REQUIREMENTS OF THE VIRGINIA DEPARTMENT OF TRANSPORTATION.
- 15,-DISTANCES & RADII REFERRED TO ARE TO THE EDGE OF PAVEMENT, UNLESS OTHERWISE NOTED.
- 16. CONTRACTOR IS RESPONSIBLE FOR THE LOCATION, IDENTIFICATION, AND REPAIR OF ALL STORMWATER RELATED STRUCTURES.
- 17. ALL TRENCHING, PIPE LAYING, AND BACKFILLING SHALL BE IN ACCORDANCE WITH FEDERAL O.S.H.A. REGULATIONS AND OTHER LOCAL AND STATE RULES AND REGULATIONS.
- 18. ENGINEERED FILL SHOULD CONSIST OF CLEAN SOIL FILL, COMPACTED 6" TO 8" LIFTS TO A MINIMUM COMPACTIVE EFFORT OF 95% OF STANDARD PROCTOR MAXIMUM DRY DENSITY (ASTM D-698). MOISTURE CONTENT SHOULD BE MAINTAINED WITHIN 2 TO 3 PERCENTAGE POINTS OF OPTIMUM MOISTURE CONTENT TO FACILITATE COMPACTION, EACH LIFT OF FILL SHOULD BE TESTED IN ORDER TO CONFIRM THAT THE RECOMMENDED DEGREE OF COMPACTION IS ACHIEVED. FILL MATERIAL: ASTM D 2487, CLASSIFICATION GW. GP. GM. GC. SW. SP, SM, SC WITH A MAXIMUM ASTM D 4318 LIQUID LIMIT OF 35, MAXIMUM ASTM D 4318 PLASTICITY INDEX OF 12, AND A MAXIMUM OF 25 PERCENT BY WEIGHT PASSING ASTM D 1140, NO. 200 SIEVE. SELECT MATERIAL: ASTM D 2487, CLASSIFICATION GW, GP, SW, SP WITH A MAXIMUM OF 10 PERCENT BY WEIGHT PASSING ASTM D 1140, NO. 200 SIEVE.
- 19. OWNER, CONTRACTOR, AND ALL SUBCONTRACTORS SHALL COMPLY WITH ALL APPLICABLE CODES AND ORDINANCES GOVERNED BY STATE AND LOCAL JURISDICTION.
- 20. CONSTRUCTION SHALL COMPLY WITH ALL APPLICABLE LOCAL, STATE, AND NATIONAL CODES AND REGULATIONS.
- 21. THE CONTRACTOR SHALL NOTIFY THE ENGINEER OF ANY DISCREPANCIES PRIOR TO BIDDING.
- 22. ALL MATERIALS INDICATED ARE NEW, SHALL BE PROVIDED BY CONTRACTOR UNLESS OTHERWISE NOTED,
- 23. DURING THE COURSE OF CONSTRUCTION, IF THE CONTRACTOR UNCOVERS ANY CODE VIOLATION KNOWN TO HIM OR ANY DISCREPANCY WITH THE DESIGN, CONTRACTOR SHALL NOTIFY THE ENGINEER OF SUCH IMMEDIATELY.
- 24. ANY CONSTRUCTION WITHIN THE VDOT RIGHT OF WAY SHALL BE IN ACCORDANCE WITH THE VDOT ROAD AND BRIDGE STANDARDS AND SPECIFICATIONS AND THE VIRGINIA WORK AREA PROTECTION MANUAL ARRANGED WITH THE APPROPRIATE RESIDENCY OFFICE (SALEM AND/OR ROCKY MOUNT).
- 25. GUARDRAIL REPAIR, REPLACEMENT, AND UPGRADE OF EXISTING GUARDRAIL AS PER LOCATION AND DESIGN DIVISION INSTRUCTIONAL AND INFORMATIONAL MEMORANDUM NUMBER IIM-LD-220.2 DATED NOV. 21, 2003. NEW INSTALLATIONS SHOULD BE IN ACCORDANCE WITH THE
- 26. TOPOGRAPHIC AERIAL SURVEY PROVIDED BY VIRGINIA RESOURCE MAPPING. FIELD VERIFICATION PROVIDED BY COMPASS POINT LAND SURVEYING AND CORNERSTONE LAND SURVEYING.
- 27. RIM ELEVATIONS OF VAULTS AND/OR MANHOLES IN THE VDOT RIGHT OF WAY SHALL BE COUNTSUNK ONE (1) TO TWO (2) INCHES BELOW FINAL GRADE ELEVATION.
- 28. WATERLINE TRENCH WALLS SHALL BE A MINIMUM OF ONE (1) FOOT FROM THE EXISTING EDGE OF PAVEMENT AND THREE (3) FEET FROM THE EXISTING GUARDRAIL. IF THE INTEGRITY OF THE EXISTING STRUCTURES OR PAVEMENT IS COMPROMISED, THEY SHALL BE REPLACED AS DIRECTED BY THE VIRGINIA DEPARTMENT OF TRANSPORTATION.
- 29. THE CONTRACTOR SHALL ARRANGE FOR AN APPROVED TESTING LABORATORY TO CONDUCT THE NECESSARY COMPACTION TESTS AT HIS OWN EXPENSE. TEST RESULTS SHALL BE SUBMITTED DIRECTLY FROM THE LAB TO THE ENGINEER.
- 30. CONSTRUCTION REQUIRING LANE AND SHOULDER CLOSURES SHALL CONFORM IN ALL RESPECTS TO THE VDOT POLICY ENTITLED LANE AND SHOULDER CLOSURES - SALEM DISTRICT AS CONTAINED IN PARAGRAPH 1013.05 OF THE SPECIAL CONDITIONS (REF: ADDENDUM NO. 1, ITEM NO. 4). CONTRACTOR SHALL COORDINATE ALL LAND AND SHOULDER CLOSURES WITH THE APPROPRIATE VDOT RESIDENCY OFFICE (SALEM AND/OR ROCKY MOUNT).
- 31. THE LOCATION OF ALL OFF-SITE FILL OR BORROW AREAS WITH THE CONSTRUCTION PROJECT WILL BE PROVIDED TO ROANOKE COUNTY DEPARTMENT OF COMMUNITY DEVELOPMENT. AN EROSION CONTROL PLAN OR MEASURES MAY BE REQUIRED FOR THIS AREA.




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C2	4 OF 9	PLAN AND PROFILE STA: 222+00 - 237+00
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C4	6 OF 9	PLAN AND PROFILE STA: 252+00 - 267+00
C 5	7 OF 9	PLAN AND PROFILE STA: 267+00 - 275+94.84
D1	8 OF 9	EROSION AND SEDIMENT CONTROL DETAILS
D2	9 OF 9	VDOT DETAILS
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EROSION AND SEDIMENT CONTROL NARRATIVE

This project consist of the installation of approximately 6,905.84 linear feet of 12-inch waterline

EXISTING SITE CONDITIONS

The site conditions vary, but in general consist of installing a 12-inch waterline within VDOT R.O.W. along the shoulder of route 220.

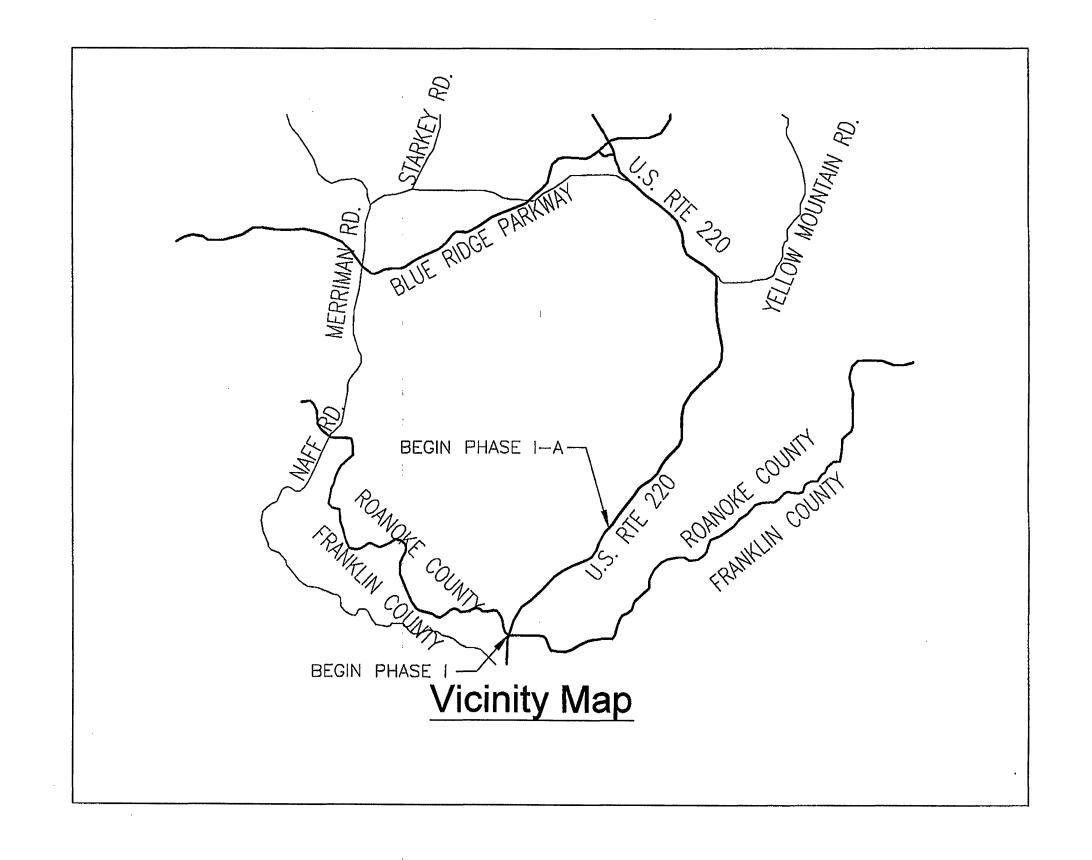No adjacent property is to be disturbed, the entire project shall remain within VDOT R.O.W. Silt fence will be installed as needed to protect all adjacent

No offsite fill or borrow areas are anticipated for thi

CRITICAL EROSION AREAS

Inlets, streams, and other critical erosion areas will be protected in accordance with the Virginia Erosion and Sediment Control Handbook Latest Edition.

All measures to be in accordance with the Virginia Erosion and Sediment Control Handbook Latest Edition.

EXISTING PROPERTY, LINE NEW 12" WATERLINE EXISTING 10' CONTOUR EXISTING STORM DRAIN EXISTING 2' CONTOUR AIR RELEASE VALVE ASSEMBLY EXISTING 10' CONTOUR (OBSCURED) FIRE HYDRANT ASSEMBLY EXISTING 2' CONTOUR (OBSCURED) 12" GATE VALVE TAX PARCEL BOUNDARY LINE BLOW OFF VALVE ASSEMBLY TREELINE SURVEY BENCHMARK ~~~~

GUARD RAIL UNDERGROUND UTILITY LINES **OBSCURED AREA** LAMP POST TRAFFIC SIGNAL UTILITY POLE

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NBL ---

SBL —

FENCE EXISTING EDGE OF PAVEMENT DENOTES NORTH BOUND LANE DENOTES SOUTH BOUND LANE


ABBREVIATIONS


ARV AIR RELEASE VALVE EX EXISTING REQ'D REQUIRED BC BACK OF CURB FIRE HYDRANT RIGHT BENCH MARK HORIZONTAL BEND RIGHT OF WAY C/C CENTER TO CENTER SANITARY SEWER C G CURB AND GUTTER IPS IRON PIN SET CIP CAST IRON PIPE STATION IPF IRON PIN FOUND CENTER LINE STD STANDARD LINEAR FEET CMP CORRUGATED METAL PIPE SIDEWALK LEFT CO CLEAN OUT TO BE ABANDONED CONC CONCRETE MH MANHOLE TO BE REMOVED CPP CORRUGATED PLASTIC PIPE NTS NOT TO SCALE TOP OF CURB O.C. ON CENTER CY CUBIC YARDS TOP OF BANK PE POLYETHYLENE DIA DIAMETER TYPICAL DIP DUCTILE IRON PIPE PROP PROPOSED UNDERGROUND RCP REINFORCED CONCRETE PIPE WL EL ELEVATION WATERLINE ELEC ELECTRIC RESTR RESTRAINED WOVEN WIRE

1. THE SIZE OF THE SYMBOLS MAY VARY FROM THOSE SHOWN. 2. ALL ABBREVIATIONS AND SYMBOLS SHOWN MAY NOT BE USED.

No:	Revisions:	Date:	EART	
1	ROANOKE COUNTY COMMENTS	12/2		
2			ENVIF	
3			CONS	
4			CONS	
5			235 Oleibana A	
6			235 Claiborne Avenue Rocky Mount, VA 24151	
			www.earthenv.com	



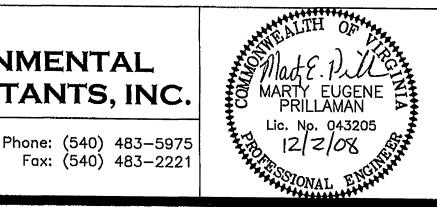

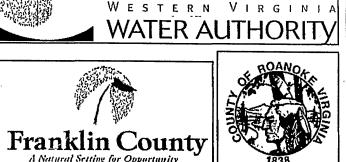

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ROANO T838	

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DESIGN BY:	PROJECT:		DATE:		
BKS/MEP DRAWN BY:	ROANOKE/FRANKLIN COUNTY U.S. F	8/12/08			
BKS	TITLE:	COUNTY, VA	DRAWING NUMBER:		
REVIEWED BY: MEP		COVER SHEET WITH GENERAL NOTES			
PROECT NUMBER: FCPP1004	DRAWING NAME: G1 COVER SHEET.dwg	SCALE: NTS	SHEET NUMBER:		

YDS

YARDS