


**STANDARD ASPHALT PAVEMENT SECTION**

NO SCALE


1. 8" STONE BASE MUST BE PLACED IN TWO LIFTS OF NO MORE THAN 4" EACH.
2. A TACK COAT SHALL BE APPLIED BETWEEN ASPHALT PAVEMENT LAYERS
3. G.C. TO ENSURE A MINIMUM OF 95% COMPACTION OF THE SUBGRADE PRIOR TO STONE/ASPHALT PLACEMENT.
4. PAVEMENT SECTION PROVIDED BY OWNER/GENERAL CONTRACTOR REQUEST AND NOT PER GEOTECH REPORT

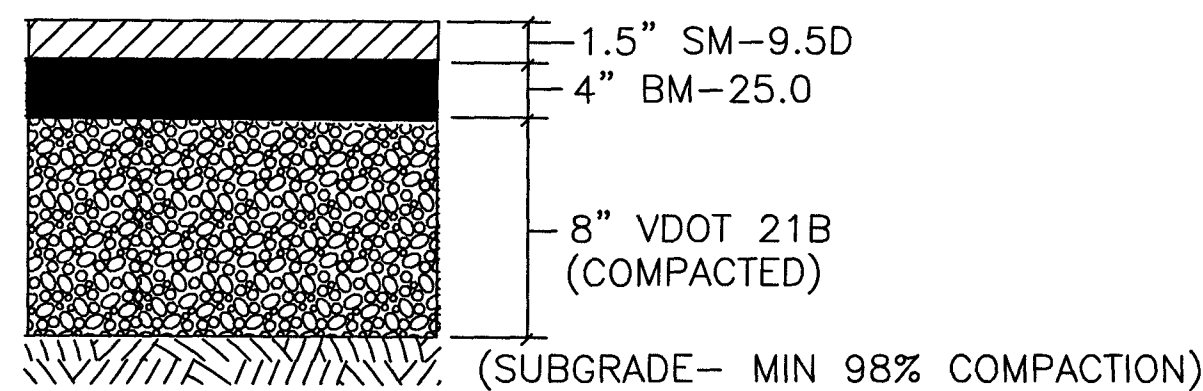

**HEAVY DUTY ASPHALT PAVEMENT SECTION**

NO SCALE

1. 8" STONE BASE MUST BE PLACED IN TWO LIFTS OF NO MORE THAN 4" EACH.
2. A TACK COAT SHALL BE APPLIED BETWEEN ASPHALT PAVEMENT LAYERS
3. G.C. TO ENSURE A MINIMUM OF 95% COMPACTION OF THE SUBGRADE PRIOR TO STONE/ASPHALT PLACEMENT.
4. PAVEMENT SECTION PROVIDED BY OWNER/GENERAL CONTRACTOR REQUEST AND NOT PER GEOTECH REPORT
5. HEAVY DUTY PAVEMENT SHALL BE PROVIDED FOR ALL DRIVE AISLE ON-SITE.

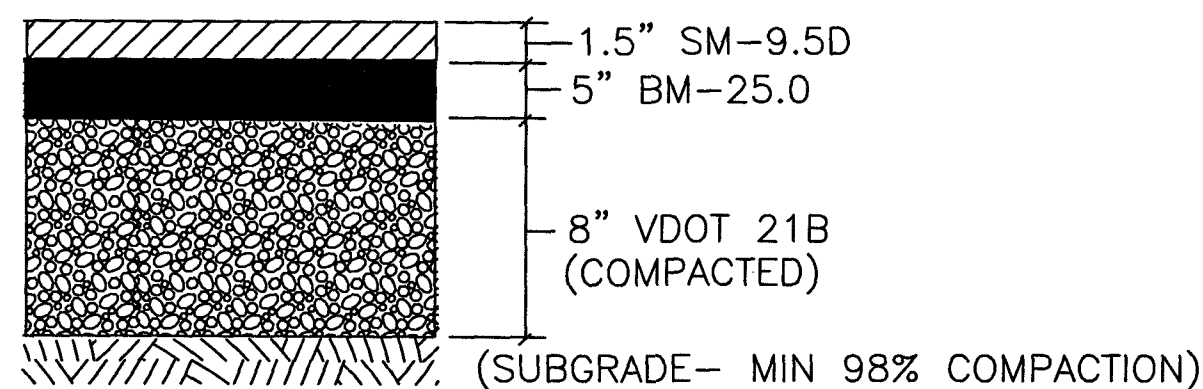


**GANDER WAY PAVEMENT SECTION**

NO SCALE

NOTE: PER APPROVED CIVIL SITE PLANS BY LUMSDEN DATED 6-5-2007

1. PAVING CONTRACTOR TO COORDINATE LIFTS WITHIN THE RIGHT OF WAY PAVEMENT AND TURN LANE PAVEMENT.
2. 12" STONE BASE MUST BE PLACED IN TWO LIFTS OF NO MORE THAN 6" EACH.
3. THE 8" INTERMEDIATE COURSE MUST BE PLACED IN TWO LIFTS OF NO MORE THAN 3" EACH.
4. A TACK COAT SHALL BE APPLIED BETWEEN ASPHALT PAVEMENT LAYERS
5. G.C. TO ENSURE A MINIMUM OF 98% COMPACTION OF THE SUBGRADE PRIOR TO STONE/ASPHALT PLACEMENT.

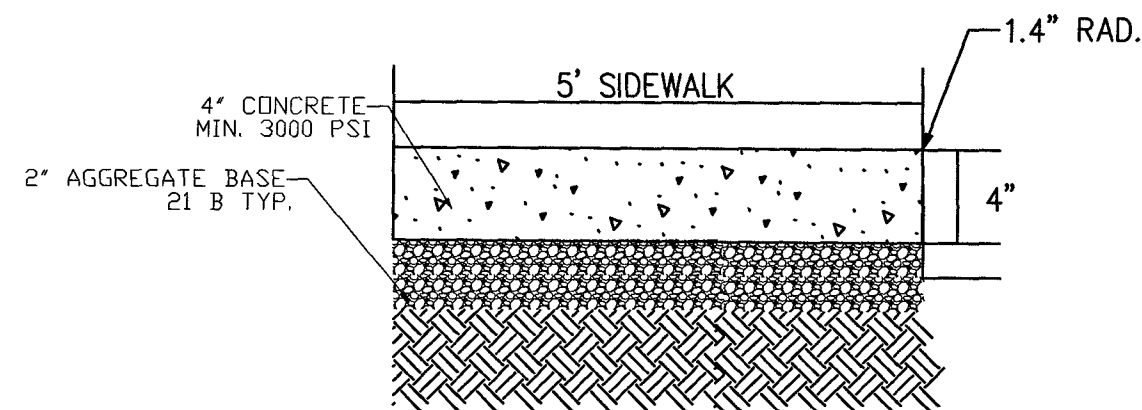


NOTE:  
FINISH - TROWELED EDGES, BROOM FINISH  
SCORING EVERY 6"  
EXPANSION JOINTS EVERY 30' MIN.

G.C. SHALL BE RESPONSIBLE FOR OBTAINING  
ADEQUATE SUB-GRADE COMPACTION.

**SIDEWALK DETAIL**


N.T.S.

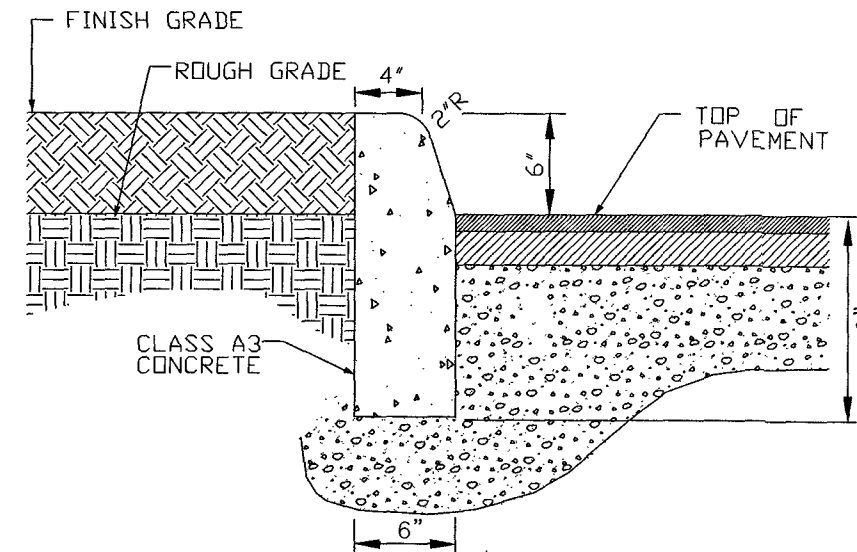

**CG-2 DETAIL TYP.**

N.T.S.


(SUBGRADE- MIN 98% COMPACTION)

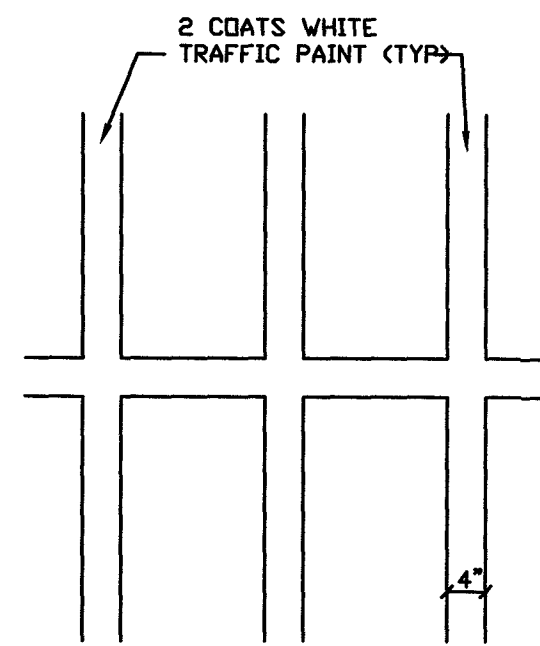

NOTE: SEE SITE PLAN FOR LAYOUT  
OF PARKING LOT STRIPING.


**PAVEMENT STRIPING DETAIL**

N.T.S.

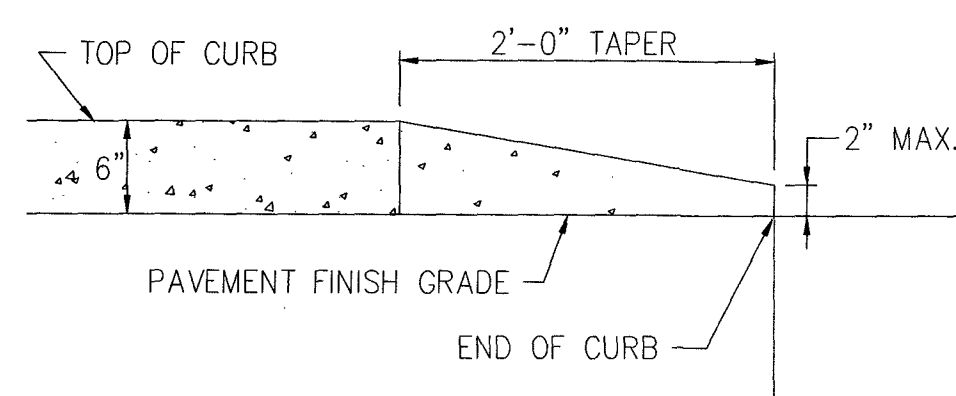


**CURB TAPER DETAIL - SECTION**

NO SCALE

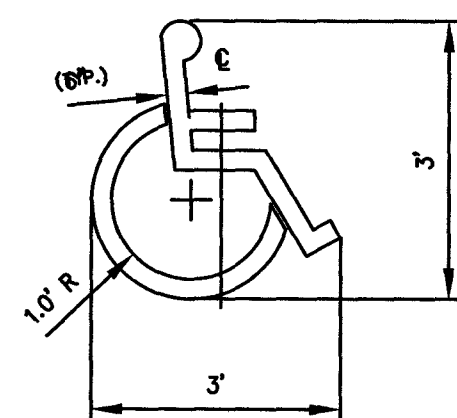

**ACCESSIBLE PARKING SYMBOL**


LOCATE AT EDGE OF PARKING SPACE UNLESS ACCOMPANIED BY "VAN"  
LETTERING

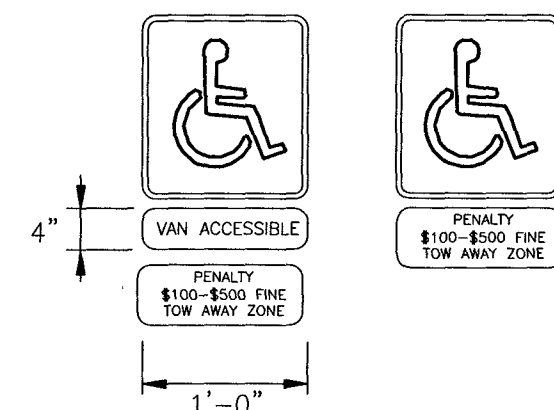

**HANDICAP SIGN DETAIL**


NO SCALE

- HANDICAP SIGN NOTES:
1. THE PROPOSED SIGNAGE SHALL BE INSTALLED PER ADA STANDARDS.
  2. ALL SIGNS SHALL BE REFLECTORIZED
  3. ALL SIGNS SHALL BE SECURELY MOUNTED TO A METAL SIGN POST. THE POST SHALL BE EMBEDDED IN CONCRETE AT THE BASE TO ENSURE STABILITY.
  4. ALL HANDICAP PARKING SPACE SIGNS SHALL HAVE THE BOTTOM EDGE OF THE SIGN NO LOWER THAN FOUR FEET NOR HIGHER THAN SEVEN FEET ABOVE THE PARKING SURFACE.

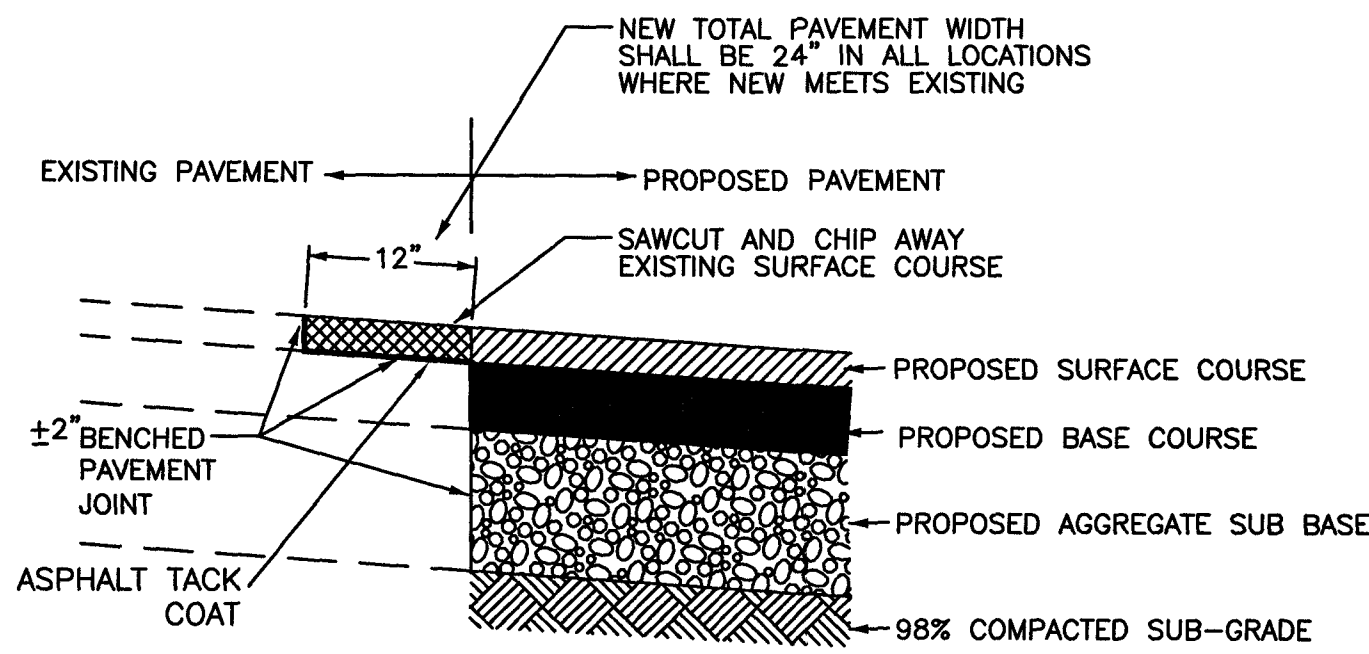


**PAVEMENT JOINT DETAIL**

N.T.S.

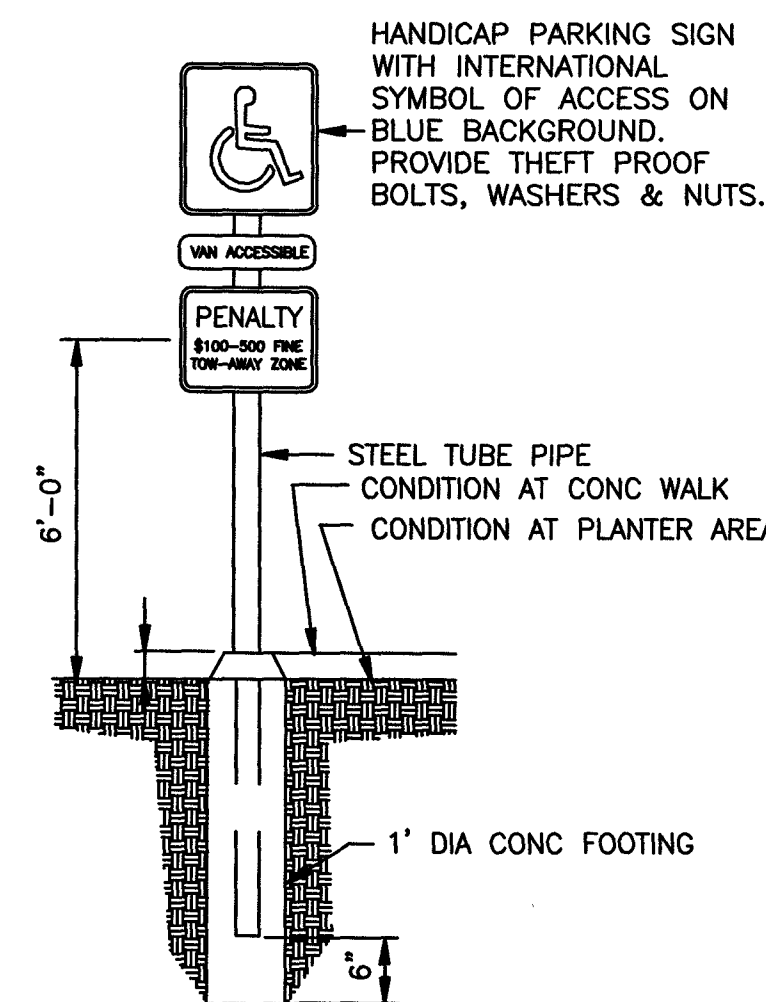


**HANDICAP SIGNPOST DETAIL**

NO SCALE


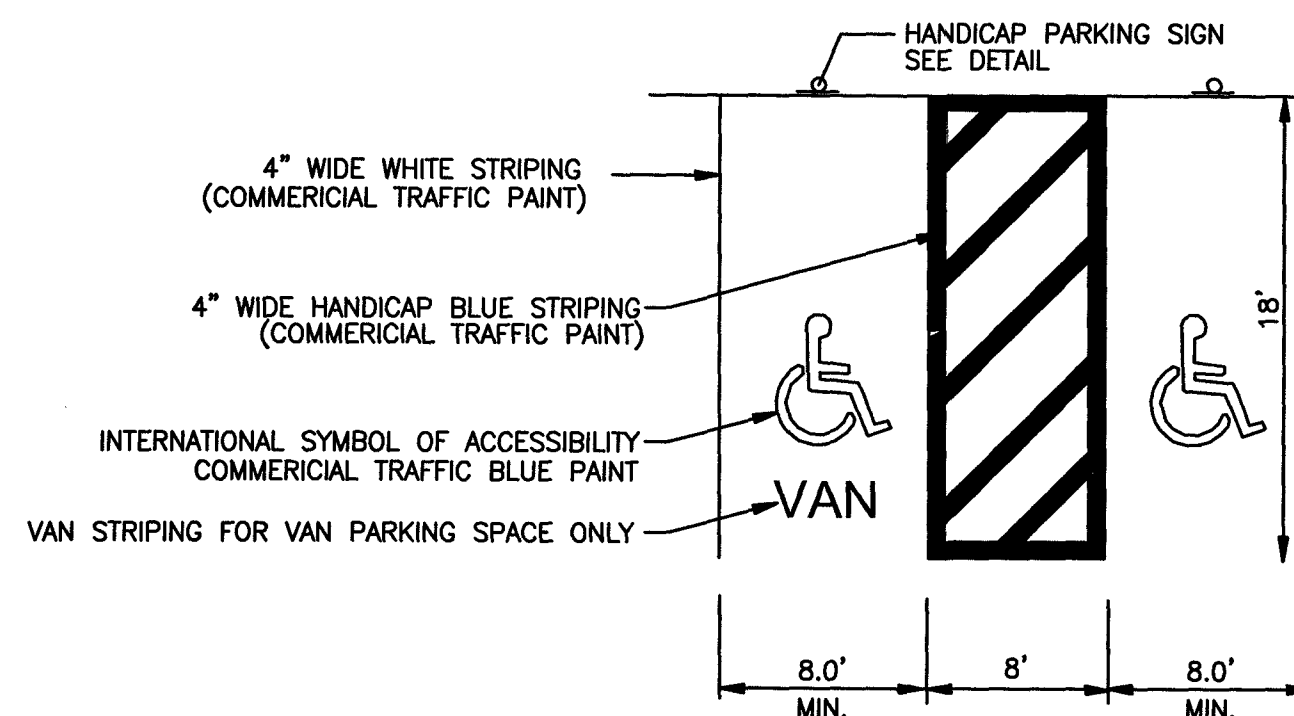


**H.C. STALL STRIPING DETAIL**

N.T.S.

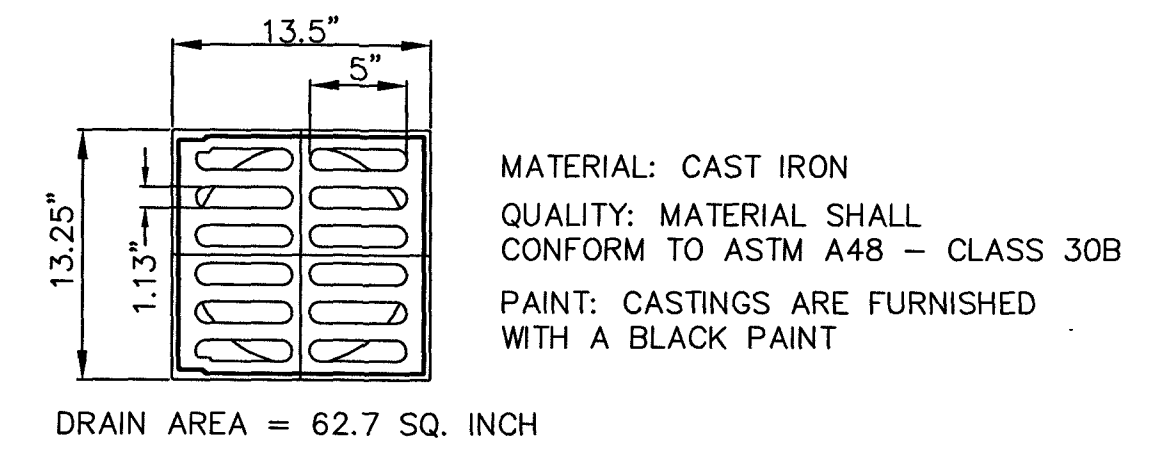

MATERIAL: CAST IRON  
QUALITY: MATERIAL SHALL  
CONFORM TO ASTM A48 - CLASS 30B  
PAINT: CASTINGS ARE FURNISHED  
WITH A BLACK PAINT

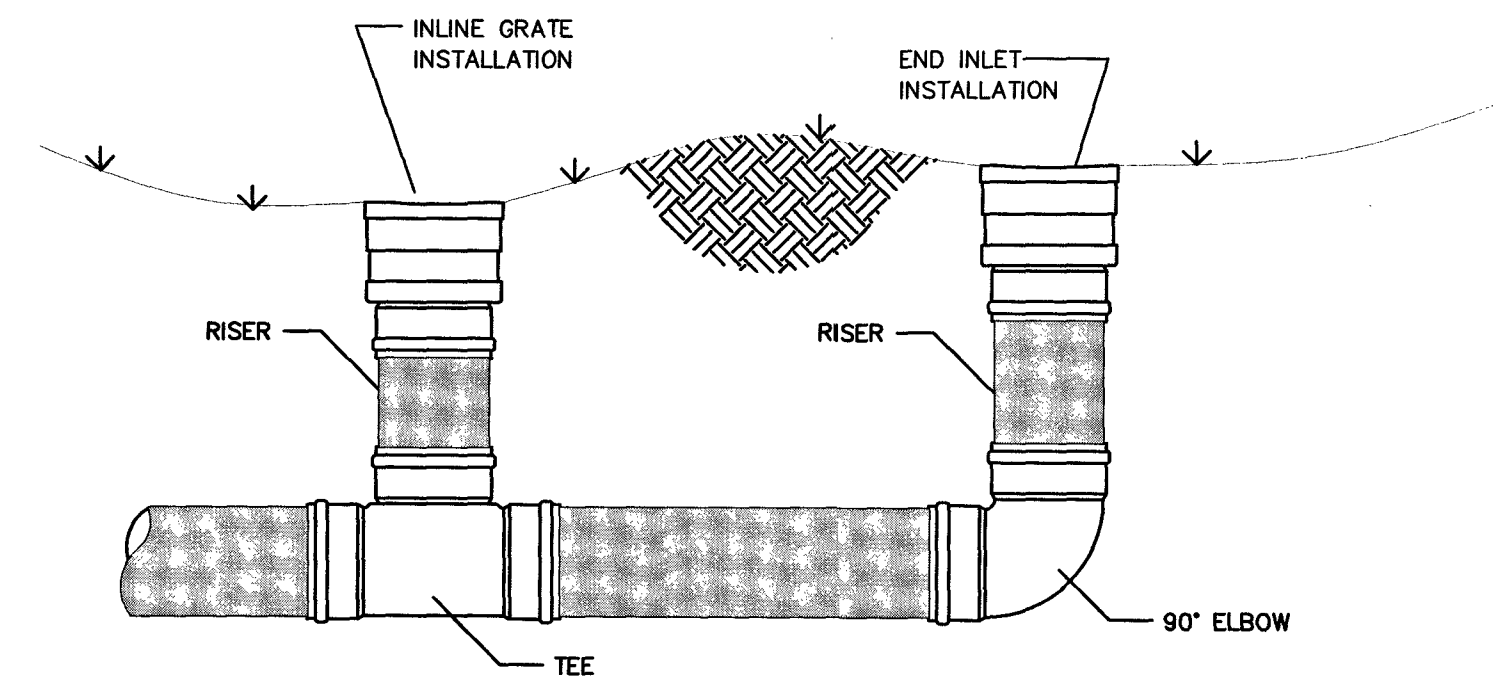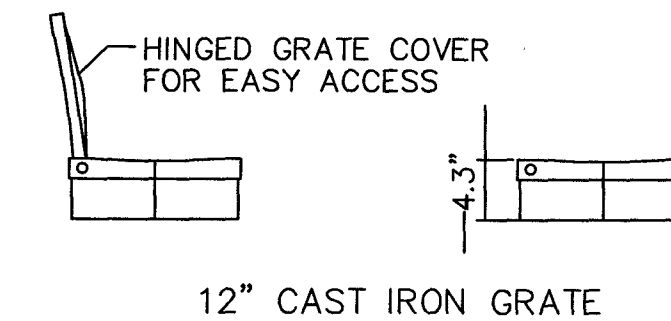


**NYLOPLAST INLET**

RECOMMENDED MANUFACTURER, APPROVED  
EQUAL MAY BE SUBSTITUTED WITH WRITTEN  
PERMISSION FROM THE ENGINEER.

- NOTE: 1.THE PROPOSED DUMPSTER ENCLOSURE SHALL BE A MINIMUM OF 1' HIGHER THAN THE DUMPSTER HEIGHT OR OTHER SIMILAR RECEPTACLE. G.C. TO CONFIRM THE PROPOSED DUMPSTER DIMENSIONS BEING USED PRIOR TO ANY CONSTRUCTION OF THE ENCLOSURE.


2. G.C. SHALL PROVIDE HEAVY DUTY HINGES AND A METAL FRAME AROUND EACH GATE TO ENSURE THAT THE PROPOSED GATE DOES NOT SAG AFTER INSTALLATION. THE FRAME SHALL BE PAINTED BLACK OR PAINTED TO MATCH THE PROPOSED GATE.

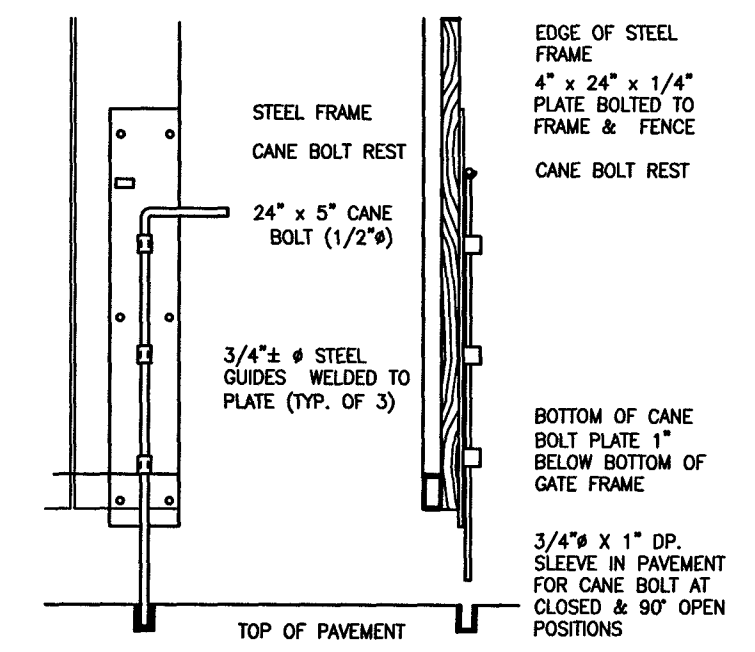

**CANE BOLT (1 PER GATE)**

**TRASH ENCLOSURE SECTION & GATE**

N.T.S.

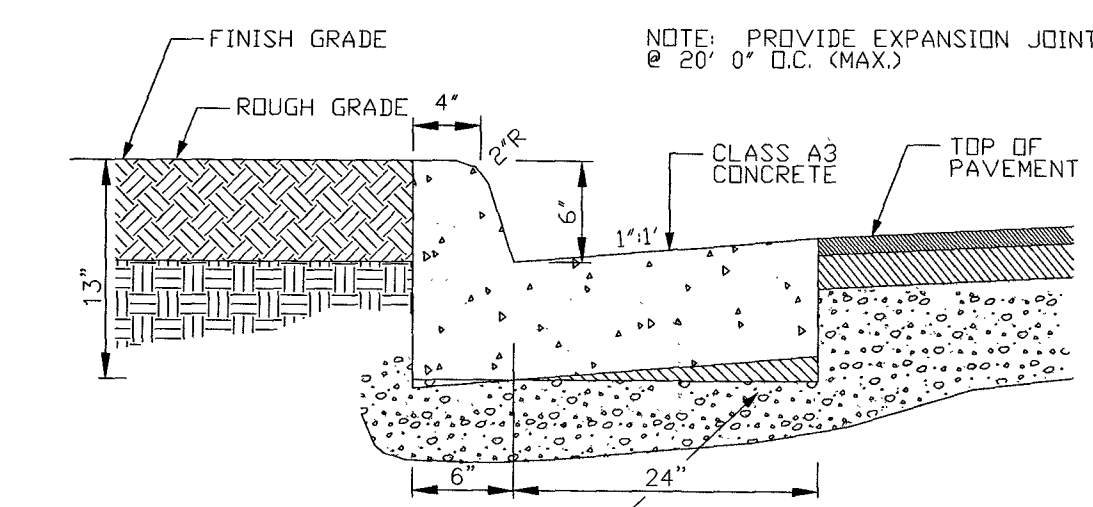

THE BOTTOM OF THE CURB & GUTTER MAY BE CONSTRUCTED PARALLEL TO THE SLOPE OF THE SUBSURFACE COURSES PROVIDED A MINIMUM DEPTH OF 7" IS MAINTAINED

NOTE:  
G.C. SHALL BE RESPONSIBLE FOR OBTAINING  
98% SUB-GRADE COMPACTION.

**CG-6 (WET) DETAIL**

N.T.S.

www.balzer.cc

Roanoke  
New River Valley  
Richmond  
Staunton  
Harrisonburg

RESIDENTIAL LAND DEVELOPMENT ENGINEERING  
SITE DEVELOPMENT ENGINEERING  
LAND USE PLANNING & ZONING  
LANDSCAPE ARCHITECTURE  
LAND SURVEYING  
ARCHITECTURE  
STRUCTURAL ENGINEERING  
TRANSPORTATION ENGINEERING  
ENVIRONMENTAL & SOIL SCIENCE  
WETLAND DELINEATIONS & STREAM EVALUATIONS


Balzer and Associates, Inc.

1208 Corporate Circle

Roanoke, VA 24018

540-772-9580

FAX 540-772-8050

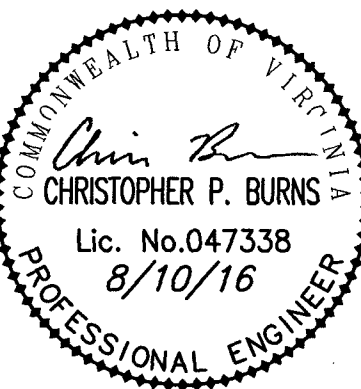

TRU BY HILTON  
GANDER WAY

DETAILS 1

ROANOKE COUNTY, VIRGINIA

DRAWN BY BTC

DESIGNED BY BTC

CHECKED BY CPB

DATE 6/17/2016

SCALE 1"=20'

REVISIONS:  
7/18/2016  
8/10/2016



SHEET NO.

**C13**

JOB NO. 04160039.00