

WESTERN VIRGINIA WATER AUTHORITY  
ROANOKE, VIRGINIA

CARVINS COVE WATER TREATMENT FACILITY  
DISINFECTION IMPROVEMENTS

AS-BUILTS  
APRIL 2015



**HAZEN AND SAWYER**  
Environmental Engineers & Scientists



RECORD DRAWINGS

THESE "RECORD DRAWINGS" REPRESENT THE FINAL CONDITIONS OF THE CONSTRUCTION PROJECT BASED UPON THE LOCATIONS, DOCUMENTATION, AND INFORMATION FURNISHED TO HAZEN & SAWYER BY OTHERS, FIELD OBSERVATION AND SUPPORTING PROJECTS RECORDS.






NOTES:  
1. PIPE WAS BEDDED IN SAND.

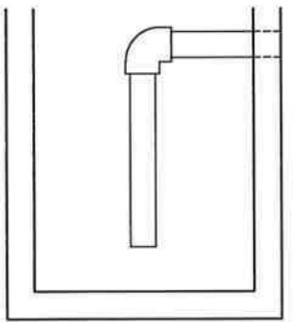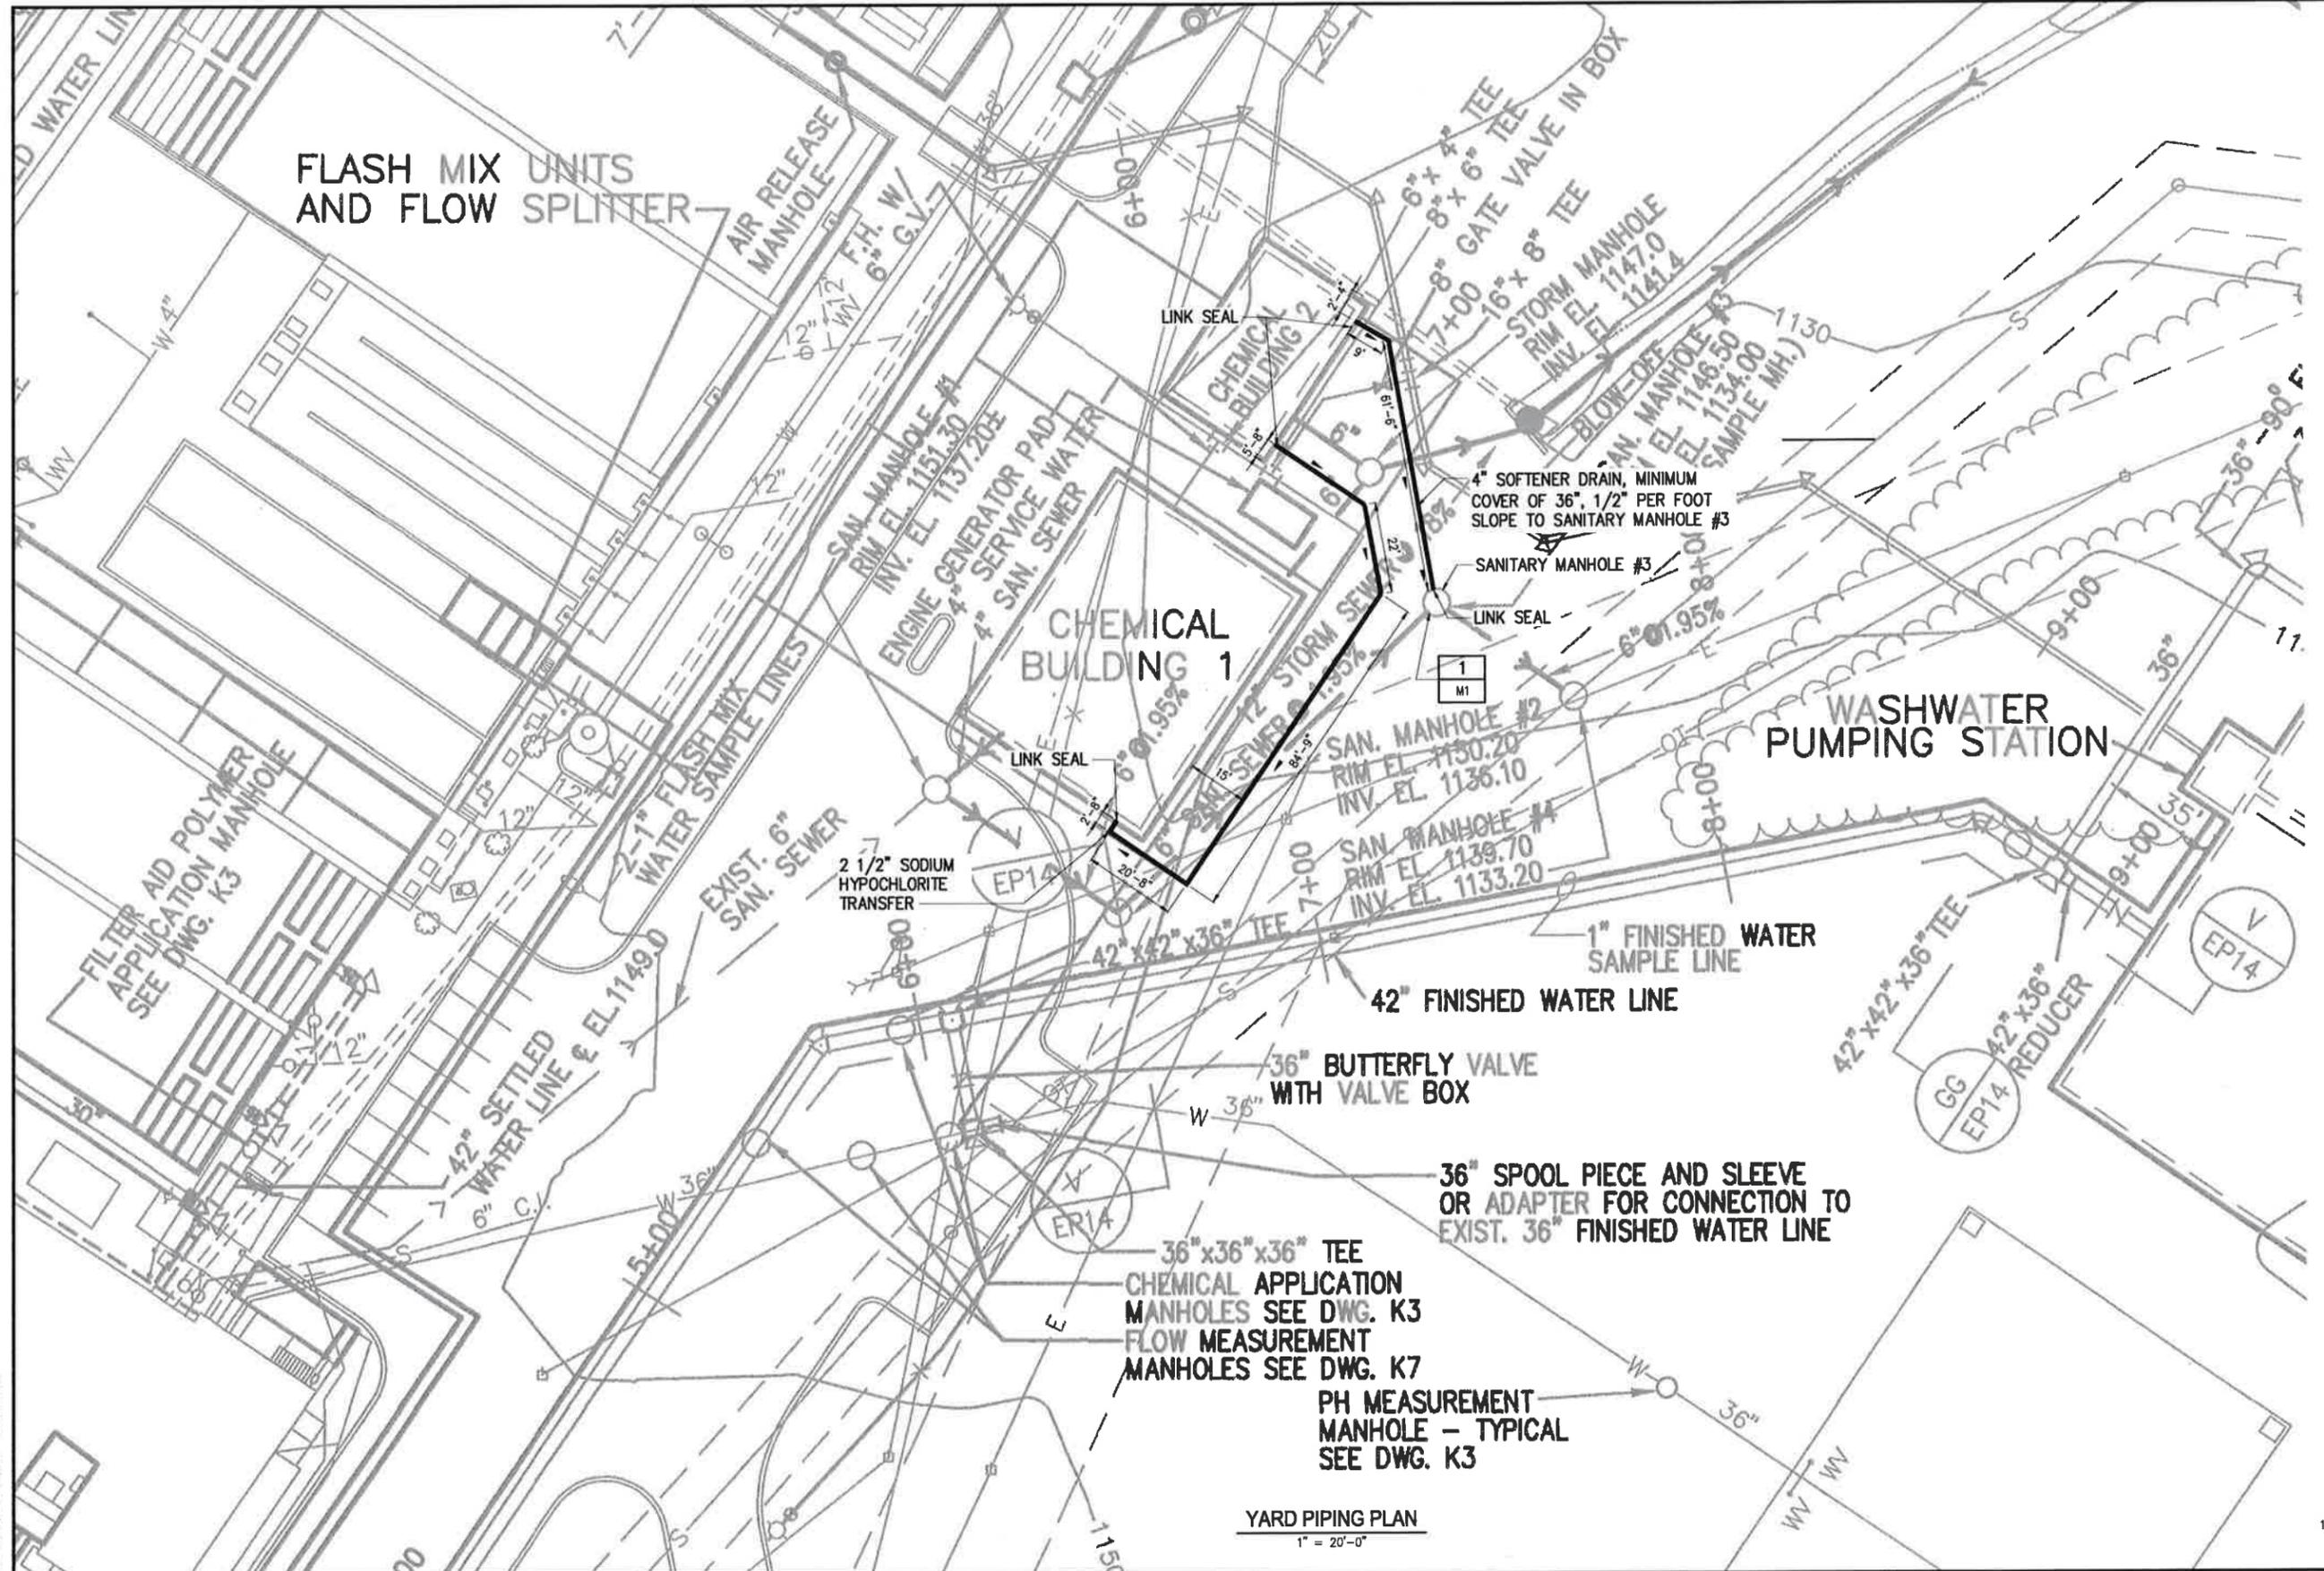

SANITARY MANHOLE 3




RECORD DRAWINGS

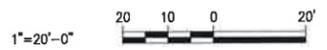

YARD PIPING PLAN  
1" = 20'-0"

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 DATE: 09/20/14 10:53 AM  
 BY: MDCZ

DESIGNED	ABL		
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PROJENGR.	ALS		
NO.	ISSUED FOR	DATE	BY
2	RECORD DRAWINGS	04/2015	ALS
1	FINAL DESIGN	09/2014	ALS
	APPROVED		

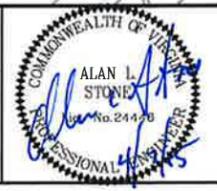

**RECORD DRAWING**  
THIS DRAWING HAS BEEN MODIFIED TO REFLECT FIELD CHANGES REPORTED BY THE CONTRACTOR OR ANOTHER PARTY, BUT NOT VERIFIED BY THE CERTIFYING ENGINEER.

THIS DOCUMENT ORIGINALLY ISSUED FOR CONSTRUCTION AND SEALED BY ALAN L. STONE, LIC NUMBER 24446

**HAZEN AND SAWYER**  
Environmental Engineers & Scientists  
4011 WestChase Boulevard, Suite 500  
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License No. : C-0381


**WESTERN VIRGINIA WATER AUTHORITY**  
ROANOKE, VIRGINIA

**CARVINS COVE WATER TREATMENT FACILITY**  
DISINFECTATION IMPROVEMENTS

**YARD PIPING PLAN**

THE SCALE BAR SHOWN BELOW MEASURES ONE INCH LONG ON THE ORIGINAL DRAWING.	DATE	OCTOBER 2014
	H&S JOB NUMBER	31197-000
	CONTRACT NUMBER	1
	DRAWING NUMBER	M1




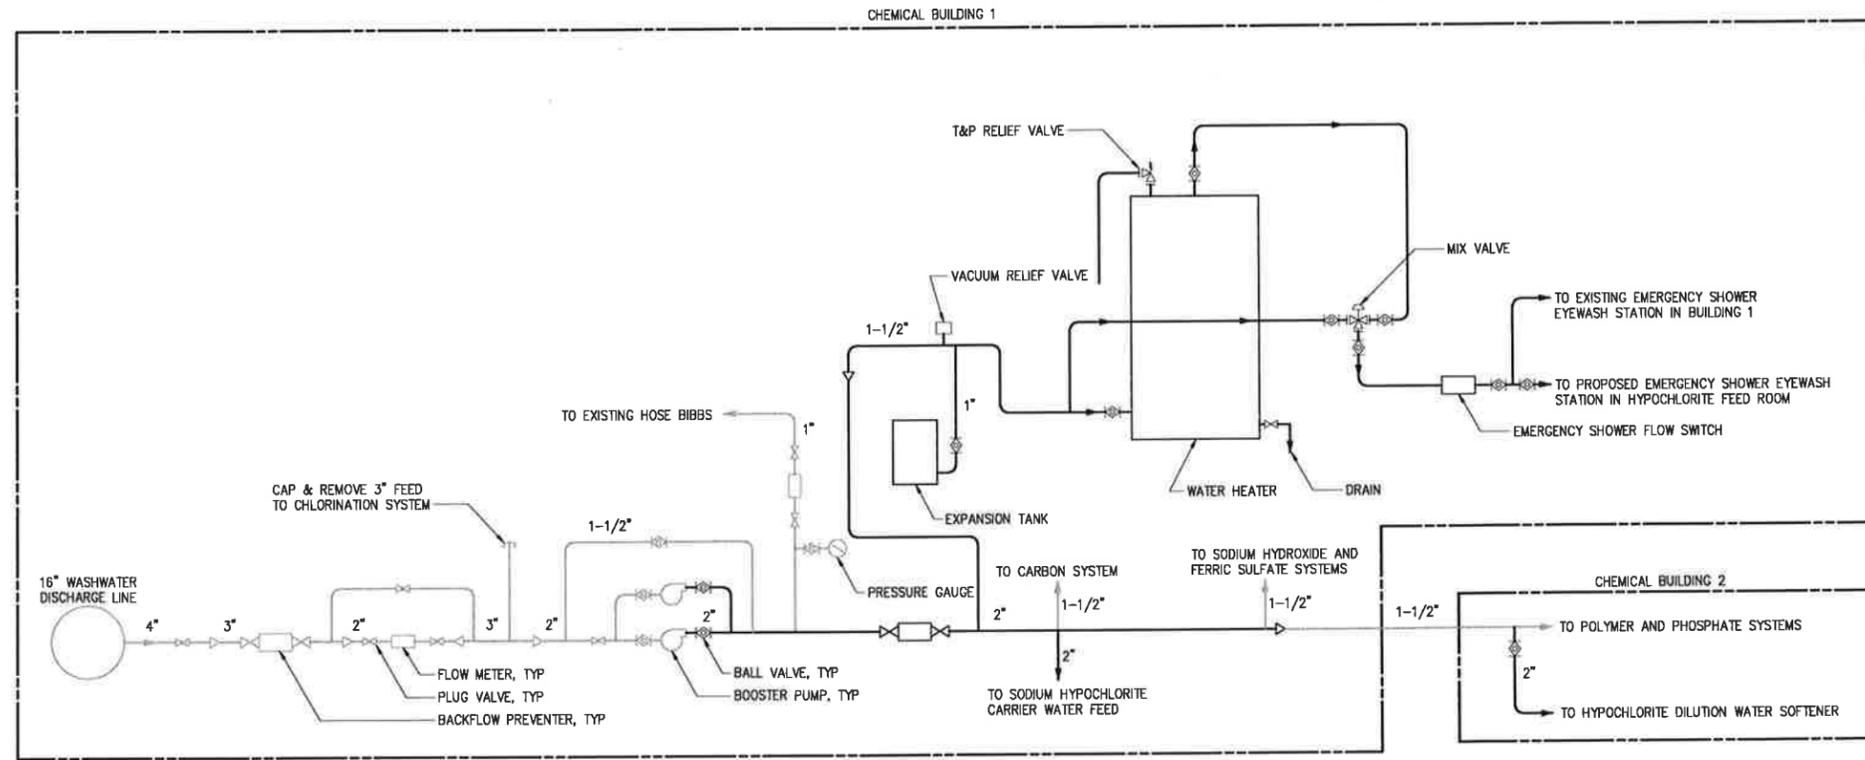

**SERVICE WATER SCHEMATIC**

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 PLOT DATE = 4/2/2015 10:33 AM BY: TUNAR

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	DATE
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 DISINFECTION IMPROVEMENTS

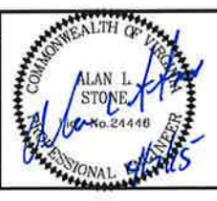
**SERVICE WATER SCHEMATIC**

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	H&S JOB NUMBER	31197-000
	CONTRACT NUMBER	1
	DRAWING NUMBER	M101

RECORD DRAWINGS





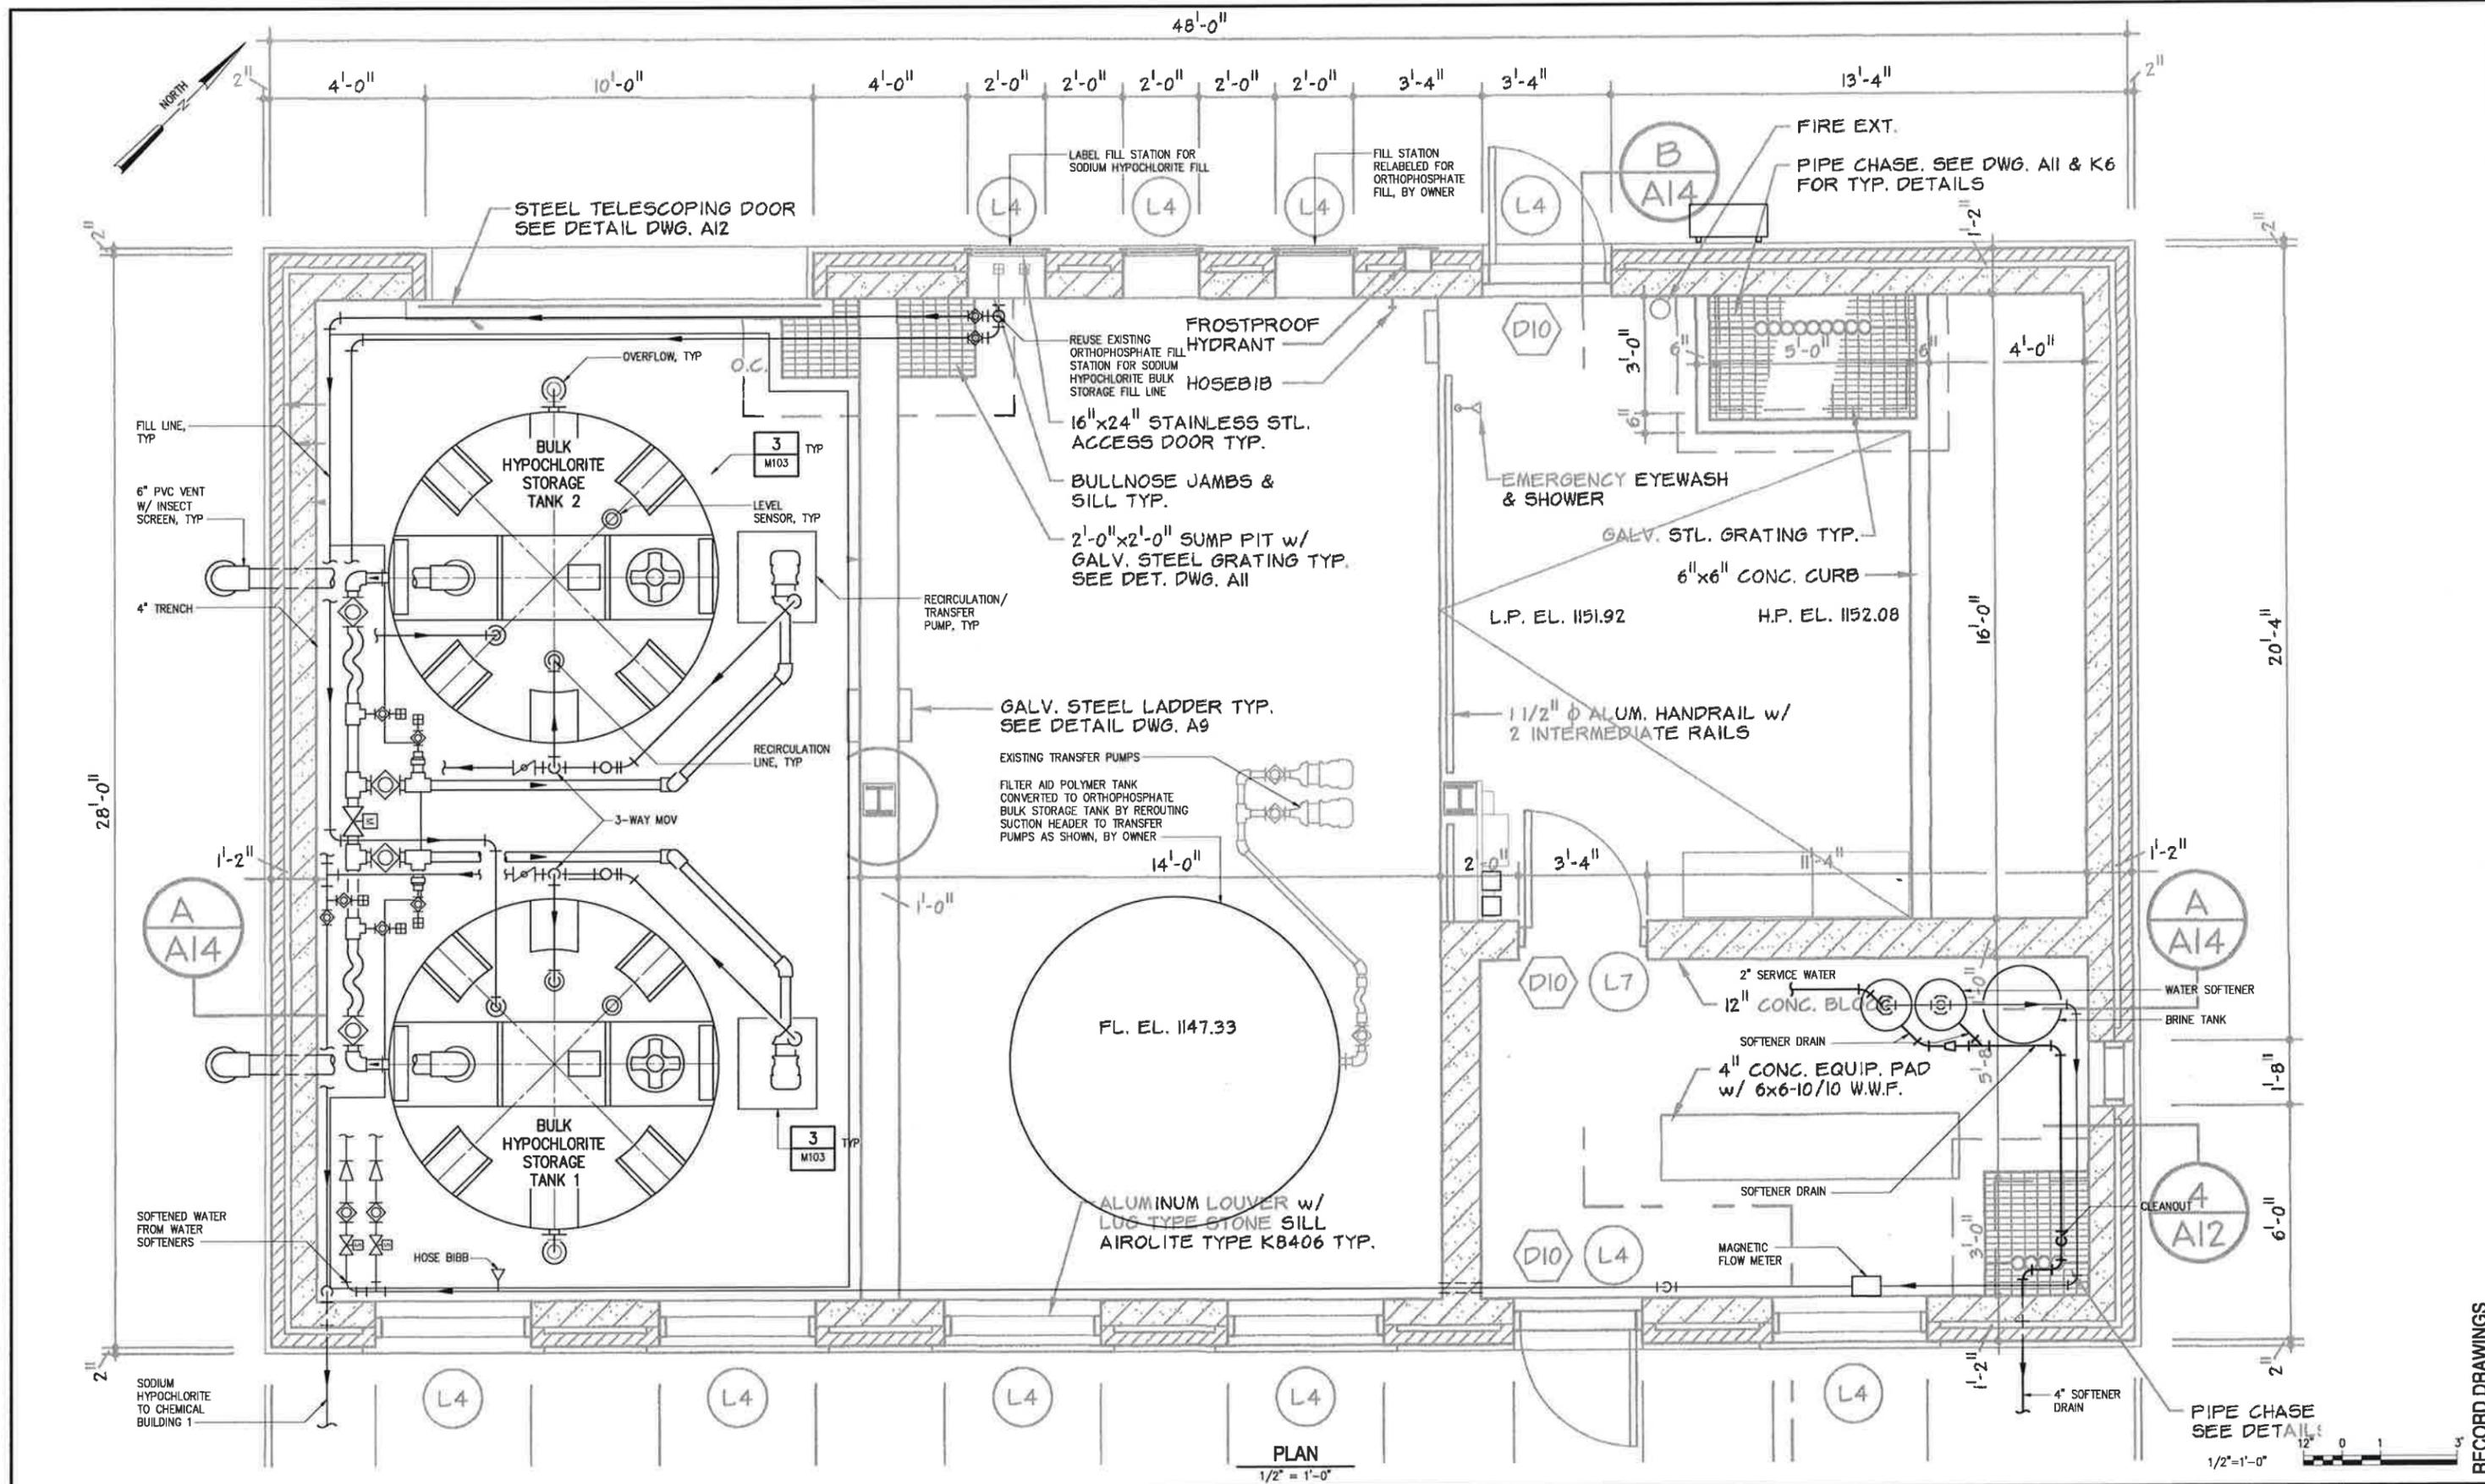


PLAN  
1/2" = 1'-0"

RECORD DRAWINGS

PLOT DATE: 10/20/2014 10:23 AM  
 PLOT BY: JBL  
 PLOT SCALE: 1/2" = 1'-0"

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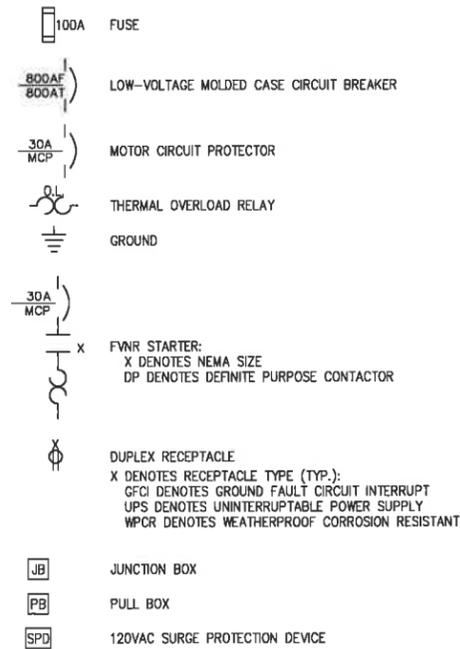
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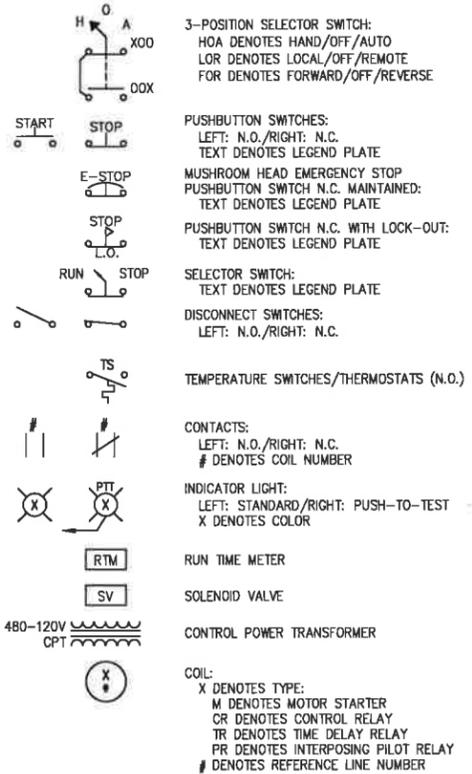
<b>CHEMICAL BUILDING 2 BULK TANK AND TRANSFER PUMPS</b>		DATE	OCTOBER 2014
		H&S JOB NUMBER	31197-000
CONTRACT NUMBER	DRAWING NUMBER		
1	M200		

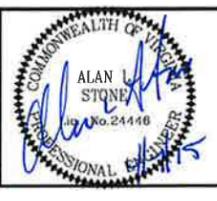THE SCALE BAR SHOWN BELOW MEASURES ONE INCH LONG ON THE ORIGINAL DRAWING.

**BLOCK DIAGRAMS**



**ELEMENTARY CONTROL SCHEMATICS**



**ABBREVIATIONS**

- ANSI AMERICAN NATIONAL STANDARDS INSTITUTE
- ASCE AMERICAN SOCIETY OF CIVIL ENGINEERS
- ASME AMERICAN SOCIETY OF MECHANICAL ENGINEERS
- ATS AUTOMATIC TRANSFER SWITCH
- BC BYPASS CONTACTOR
- CT CURRENT TRANSFORMER
- DB DUCTBANK
- DSW DISCONNECT SWITCH
- EHH ELECTRIC HAND HOLE
- EMH ELECTRIC MANHOLE
- EO ELECTRICALLY OPERATED
- FAAP FIRE ALARM ANNUCIATOR PANEL
- FACP FIRE ALARM CONTROL PANEL
- FVNR FULL VOLTAGE NON-REVERSING
- FVR FULL VOLTAGE REVERSING
- GFCI GROUND FAULT CIRCUIT INTERRUPT
- GFCT GROUND FAULT CURRENT TRANSFORMER
- IC INPUT CONTACTOR
- IEEE INSTITUTE OF ELECTRICAL AND ELECTRONICS ENGINEERS
- ISO INTL ORGANIZATION FOR STANDARDIZATION
- LCS LOCAL CONTROL STATION
- LP LIGHTING PANEL
- MFR MULTI-FUNCTION RELAY
- MOD MOTOR OPERATED DAMPER
- MOG MOTOR OPERATED GATE
- MOL MOTOR OPERATED LOUVER
- MOV MOTOR OPERATED VALVE
- MTS MANUAL TRANSFER SWITCH
- NC/NO NORMALLY CLOSED/NORMALLY OPEN
- NEC NATIONAL ELECTRICAL CODE
- NEMA NATIONAL ELECTRICAL MANUFACTURERS ASSN
- NTS NOT TO SCALE
- OC OUTPUT CONTACTOR
- OL OVERLOAD
- PC PHOTOCELL
- PCC POINT OF COMMON COUPLING
- PLC PROGRAMMABLE LOGIC CONTROLLER
- PNL PANEL
- PP POWER PANEL
- PT POTENTIAL TRANSFORMER
- RCS REMOTE CONTROL STATION
- RIO REMOTE I/O
- RVAT REDUCED VOLTAGE AUTO TRANSFORMER
- RVSS REDUCED VOLTAGE SOLID STATE
- SP. C. SPARE CONDUIT
- SST STAINLESS STEEL
- TB TEST BLOCK
- TC/TO TIMED CLOSE//TIMED OPEN
- TSH TWISTED SHIELDED
- TX TRANSFORMER
- UPS UNINTERRUPTABLE POWER SUPPLY
- VFD VARIABLE FREQUENCY DRIVE
- WPCR WEATHER PROOF CORROSION RESISTANT
- WT WALK THROUGH

**EQUIPMENT/DEVICE LOCATION SYMBOLS**

- \* LOCATED AT MCC
- △ LOCATED IN FIELD
- <sub>X</sub> LOCATED AT PANEL:  
X DENOTES PANEL ID

**NOTES:**

1. UNLESS OTHERWISE SPECIFIED OR NOTED, ALL WALL MOUNTED ELECTRICAL PANELS, ENCLOSURES, AND SIMILAR EQUIPMENT SHALL BE MOUNTED 6"-6" (MAX) FROM THE TOP OF THE PANEL TO FINISHED FLOOR OR GRADE.
2. UNLESS OTHERWISE NOTED, ALL LIGHTING SWITCHES, CONTROL SWITCHES, AND SIMILAR EQUIPMENT SHALL BE MOUNTED WITH THEIR CENTERLINE APPROXIMATELY 4'-0" ABOVE FINISHED FLOOR, SLAB, OR GRADE.
3. A SEPARATE EQUIPMENT GROUNDING CONDUCTOR SHALL BE PROVIDED FOR EACH CIRCUIT (SEPARATE CONDUCTOR IN THE CONDUIT). THE CONDUCTOR SHALL BE TERMINATED AT THE PROPER DEVICE, TERMINAL, OR LUG AT THE POWER SOURCE (MCC GROUND BUS, PANELBOARD GROUND BUS, ETC.). GROUND CONDUCTOR SIZE SHALL BE PER THE LATEST EDITION OF THE NEC.

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NO.	ISSUED FOR	DATE	BY	APPROVED
2	RECORD DRAWINGS	04/2015	ALS	
1	FINAL DESIGN	09/2014	ALS	

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DRAWN	JAD
CHECKED	
PROJ. ENGR.	ALS



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Environmental Engineers & Scientists

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ROANOKE, VIRGINIA

**CARVINS COVE WATER TREATMENT FACILITY**  
DISINFECTION IMPROVEMENTS

**ELECTRICAL**  
**LEGEND AND GENERAL NOTES**

THE SCALE BAR SHOWN BELOW MEASURES ONE INCH LONG ON THE ORIGINAL DRAWING.	DATE	OCTOBER 2014
	H&S JOB NUMBER	31197-000
	CONTRACT NUMBER	1
	DRAWING NUMBER	E1


RECORD DRAWINGS








- NOTES:**
1. MOUNT TWO NEW LEVEL INDICATING TRANSMITTERS, ONE NEW SURGE PROTECTION DEVICE AND NEW JUNCTION BOX ABOVE THE EXISTING MILLTRONICS ARANGER XPL LEVEL MEASUREMENT SYSTEM.
  2. ALL CONDUIT SHALL BE SCHEDULE 80 PVC. CONDUIT SHALL BE LISTED TO UL-651.

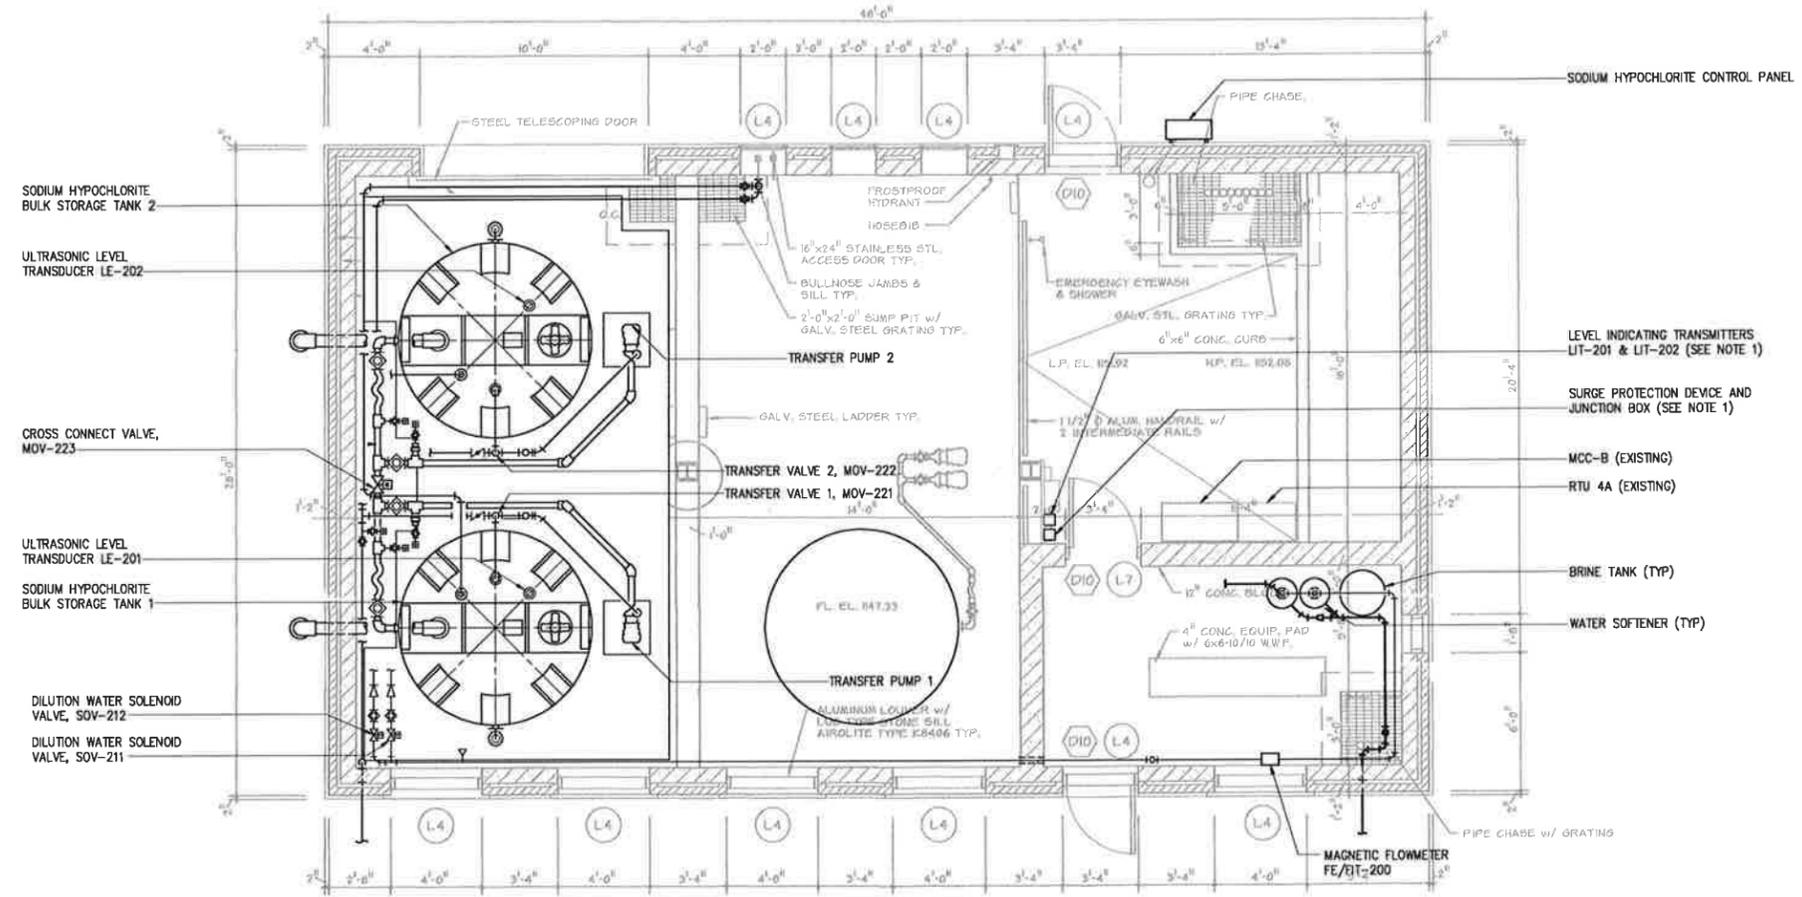

**POWER PLAN**  
1/4"=1'-0"

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NO.	ISSUED FOR	DATE	BY	APPROVED
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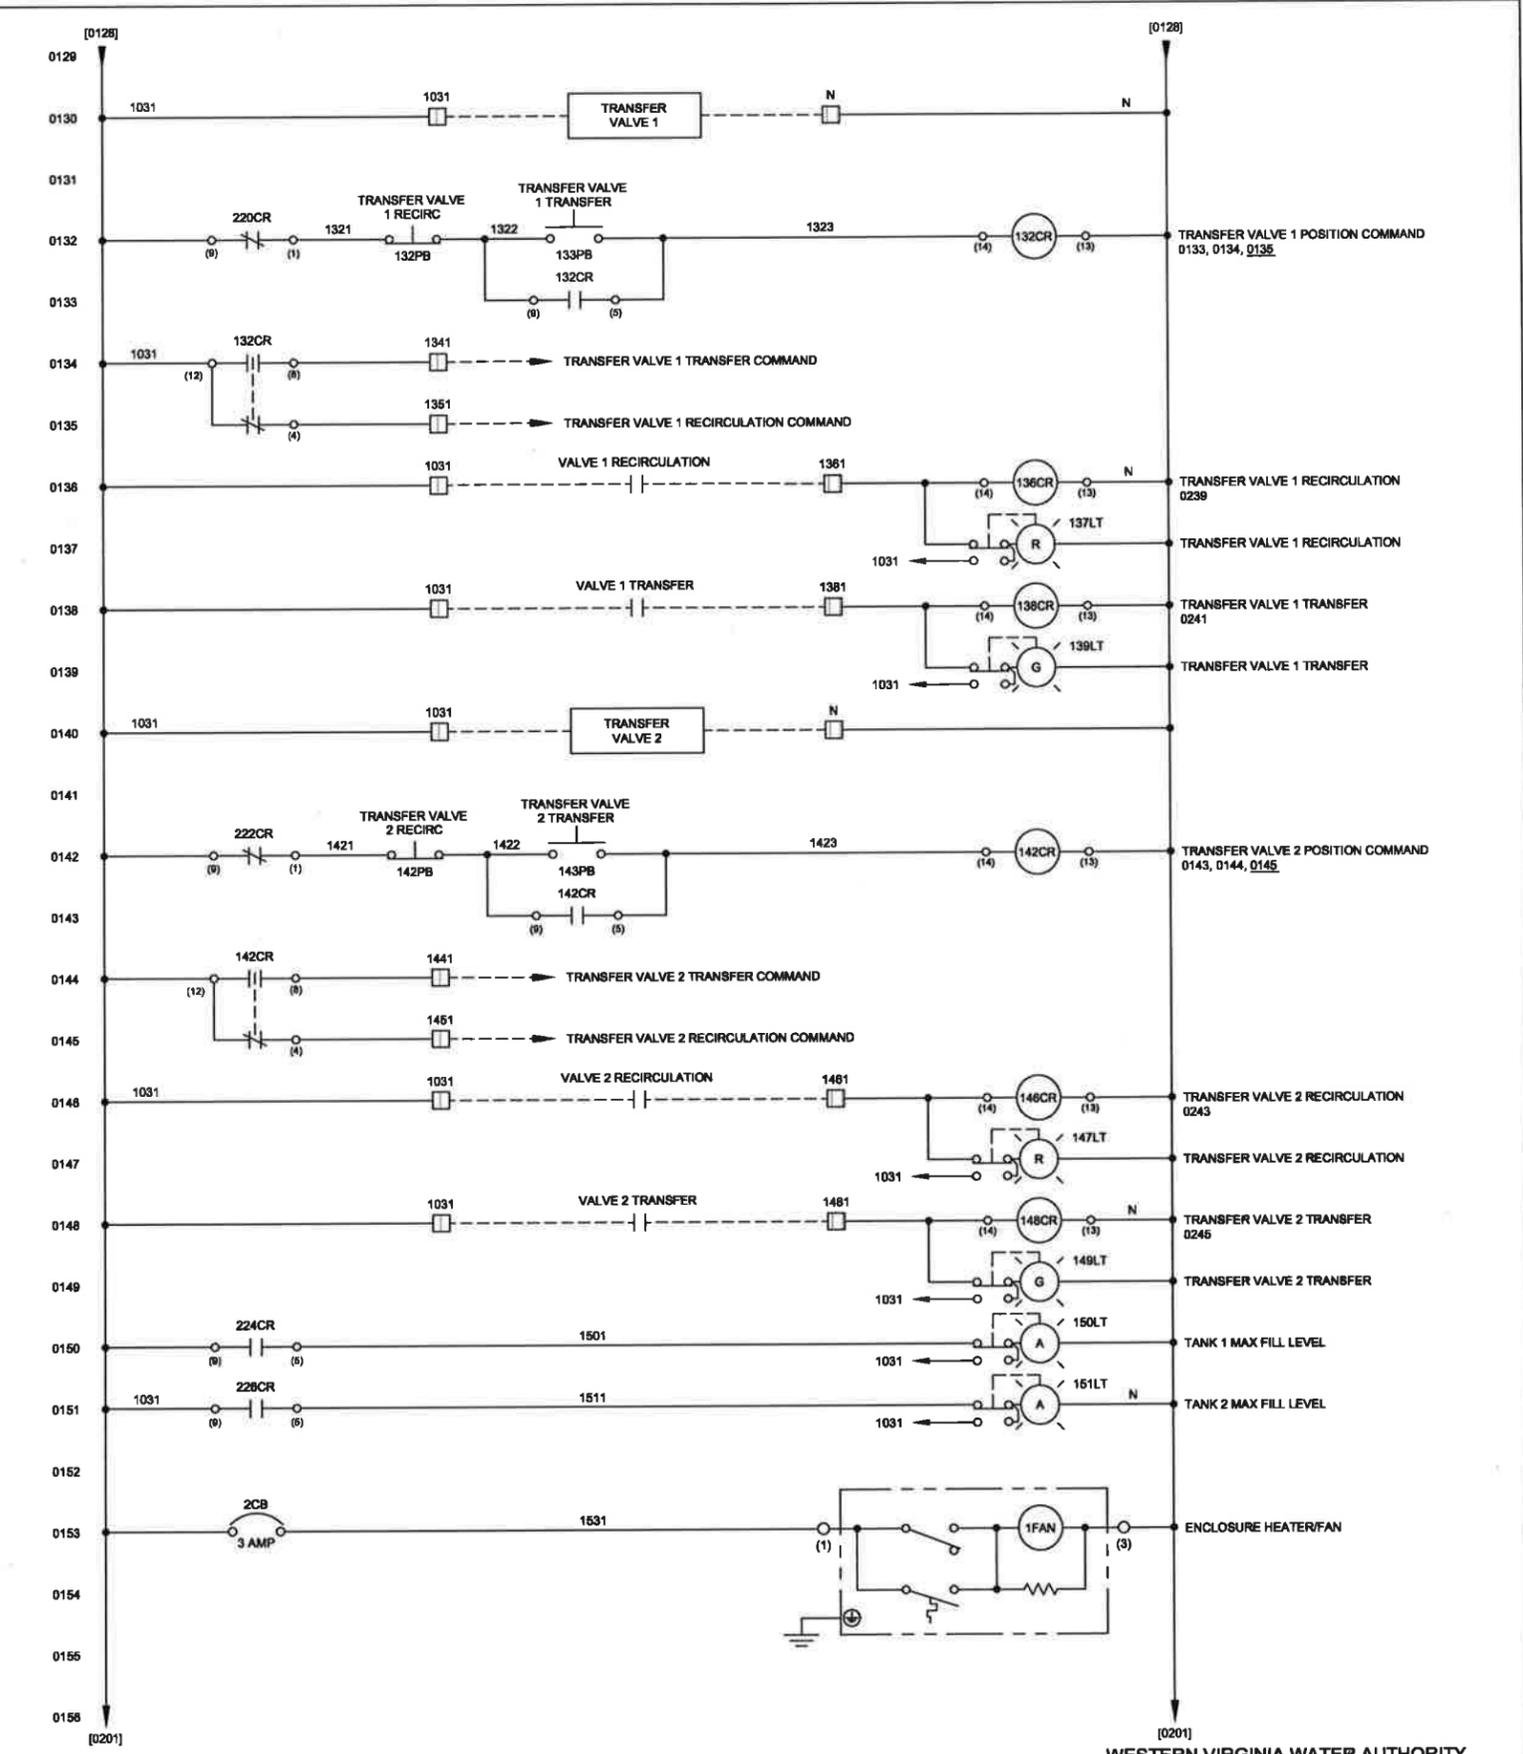
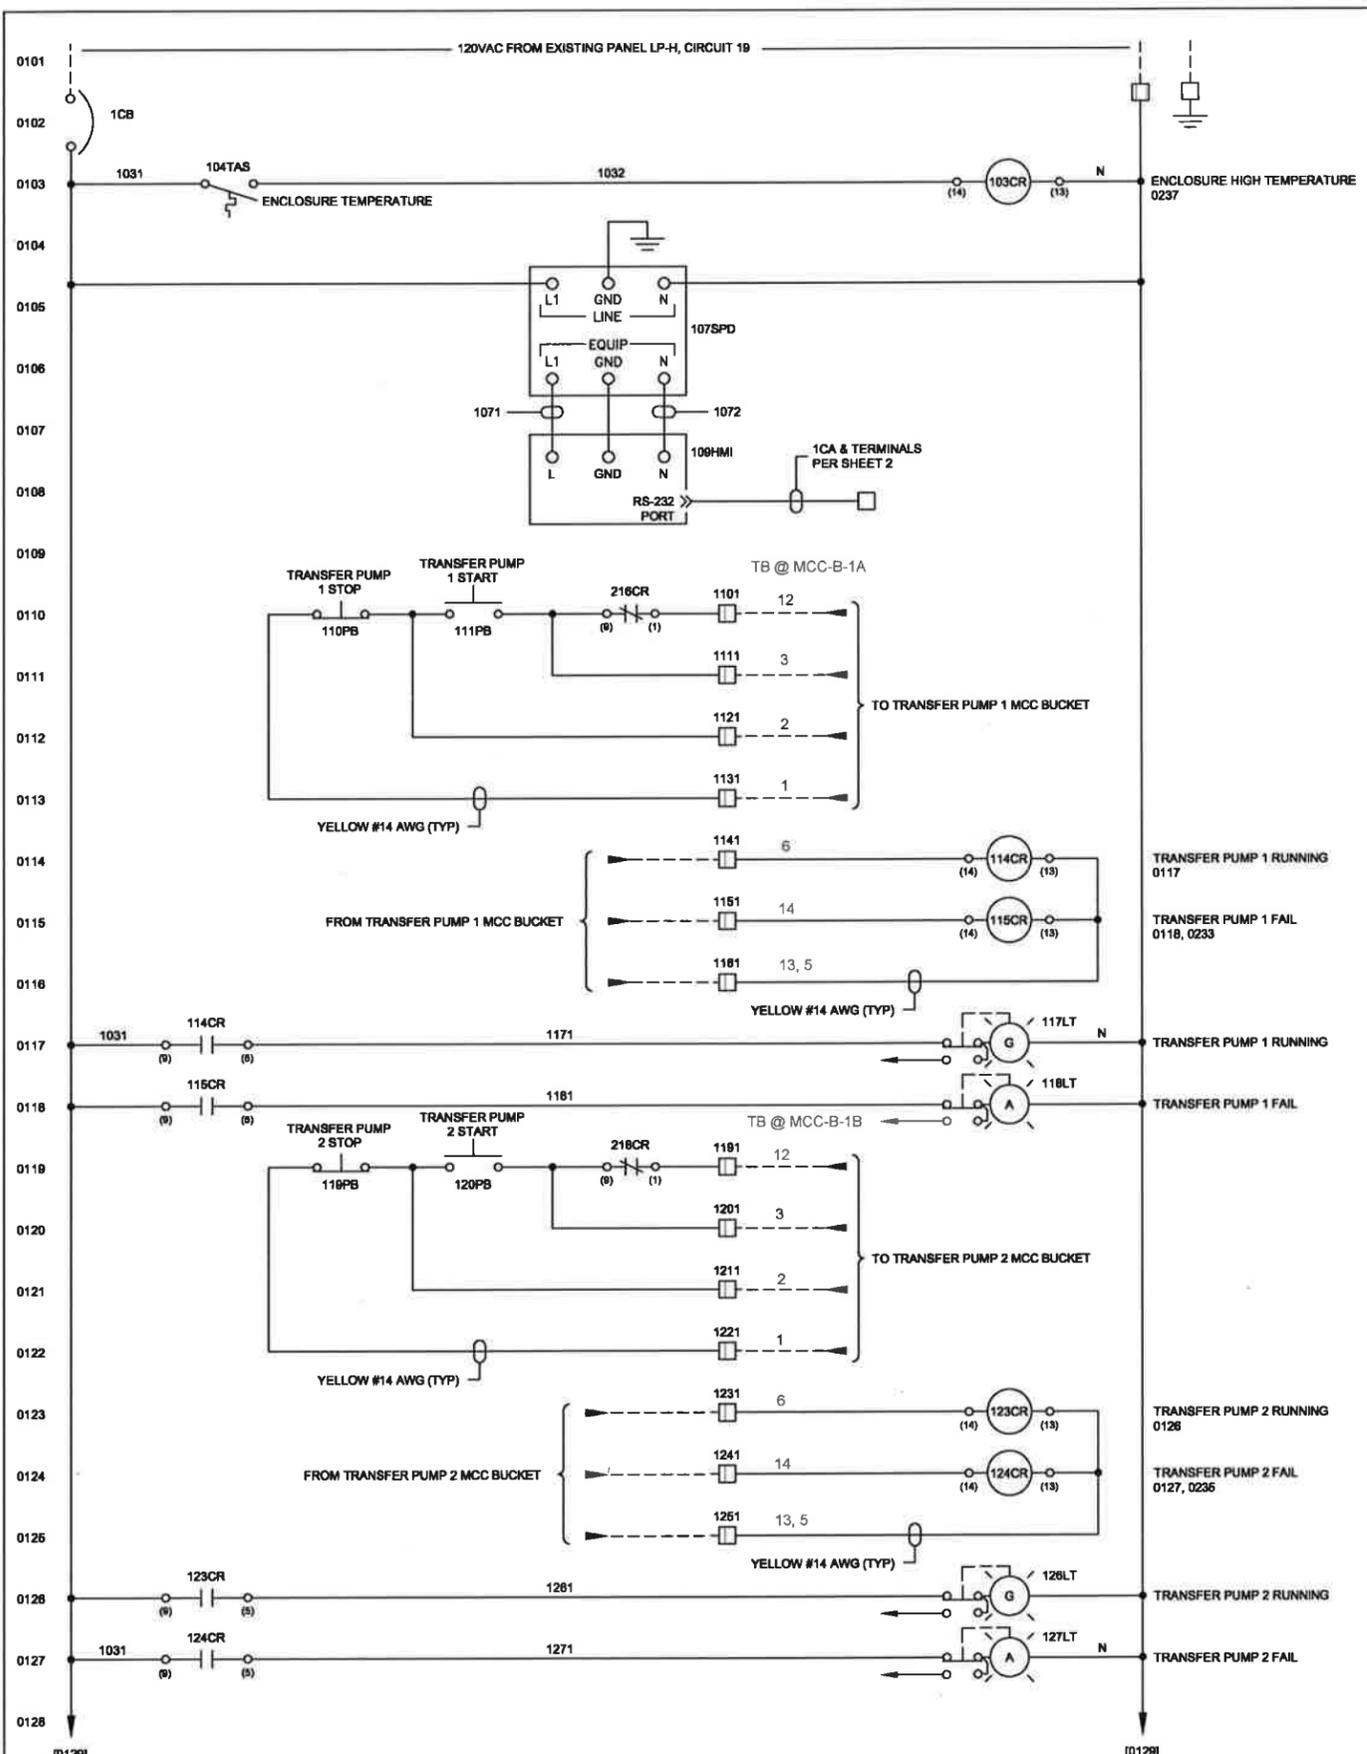
**ELECTRICAL**  
**CHEMICAL BUILDING 2 PLAN**

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	CONTRACT NUMBER	1
	DRAWING NUMBER	E200

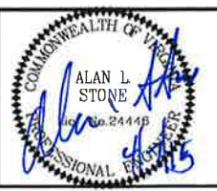RECORD DRAWINGS







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A	REVISED PER CUSTOMERS COMMENTS	ADH	-	-	10/21/2014





REV	REVISION DESCRIPTION	DRAWN	CHECKED	APP	DATE



Apex Automation & Controls  
 10991 Leadbetter Road Ashland, VA 23005  
 (804) - 550 - 1814  
 www.apex-automation.com

BY	DATE	SCALE	SHEET	OF	REVISION
ADH	10/8/14	N/A	1	of 2	A

WESTERN VIRGINIA WATER AUTHORITY  
 CARVINS COVE WTF CHEMICAL BUILDING 2  
 SODIUM HYPOCHLORITE CONTROL PANEL  
 CONTROL WIRING  
 175-14-100

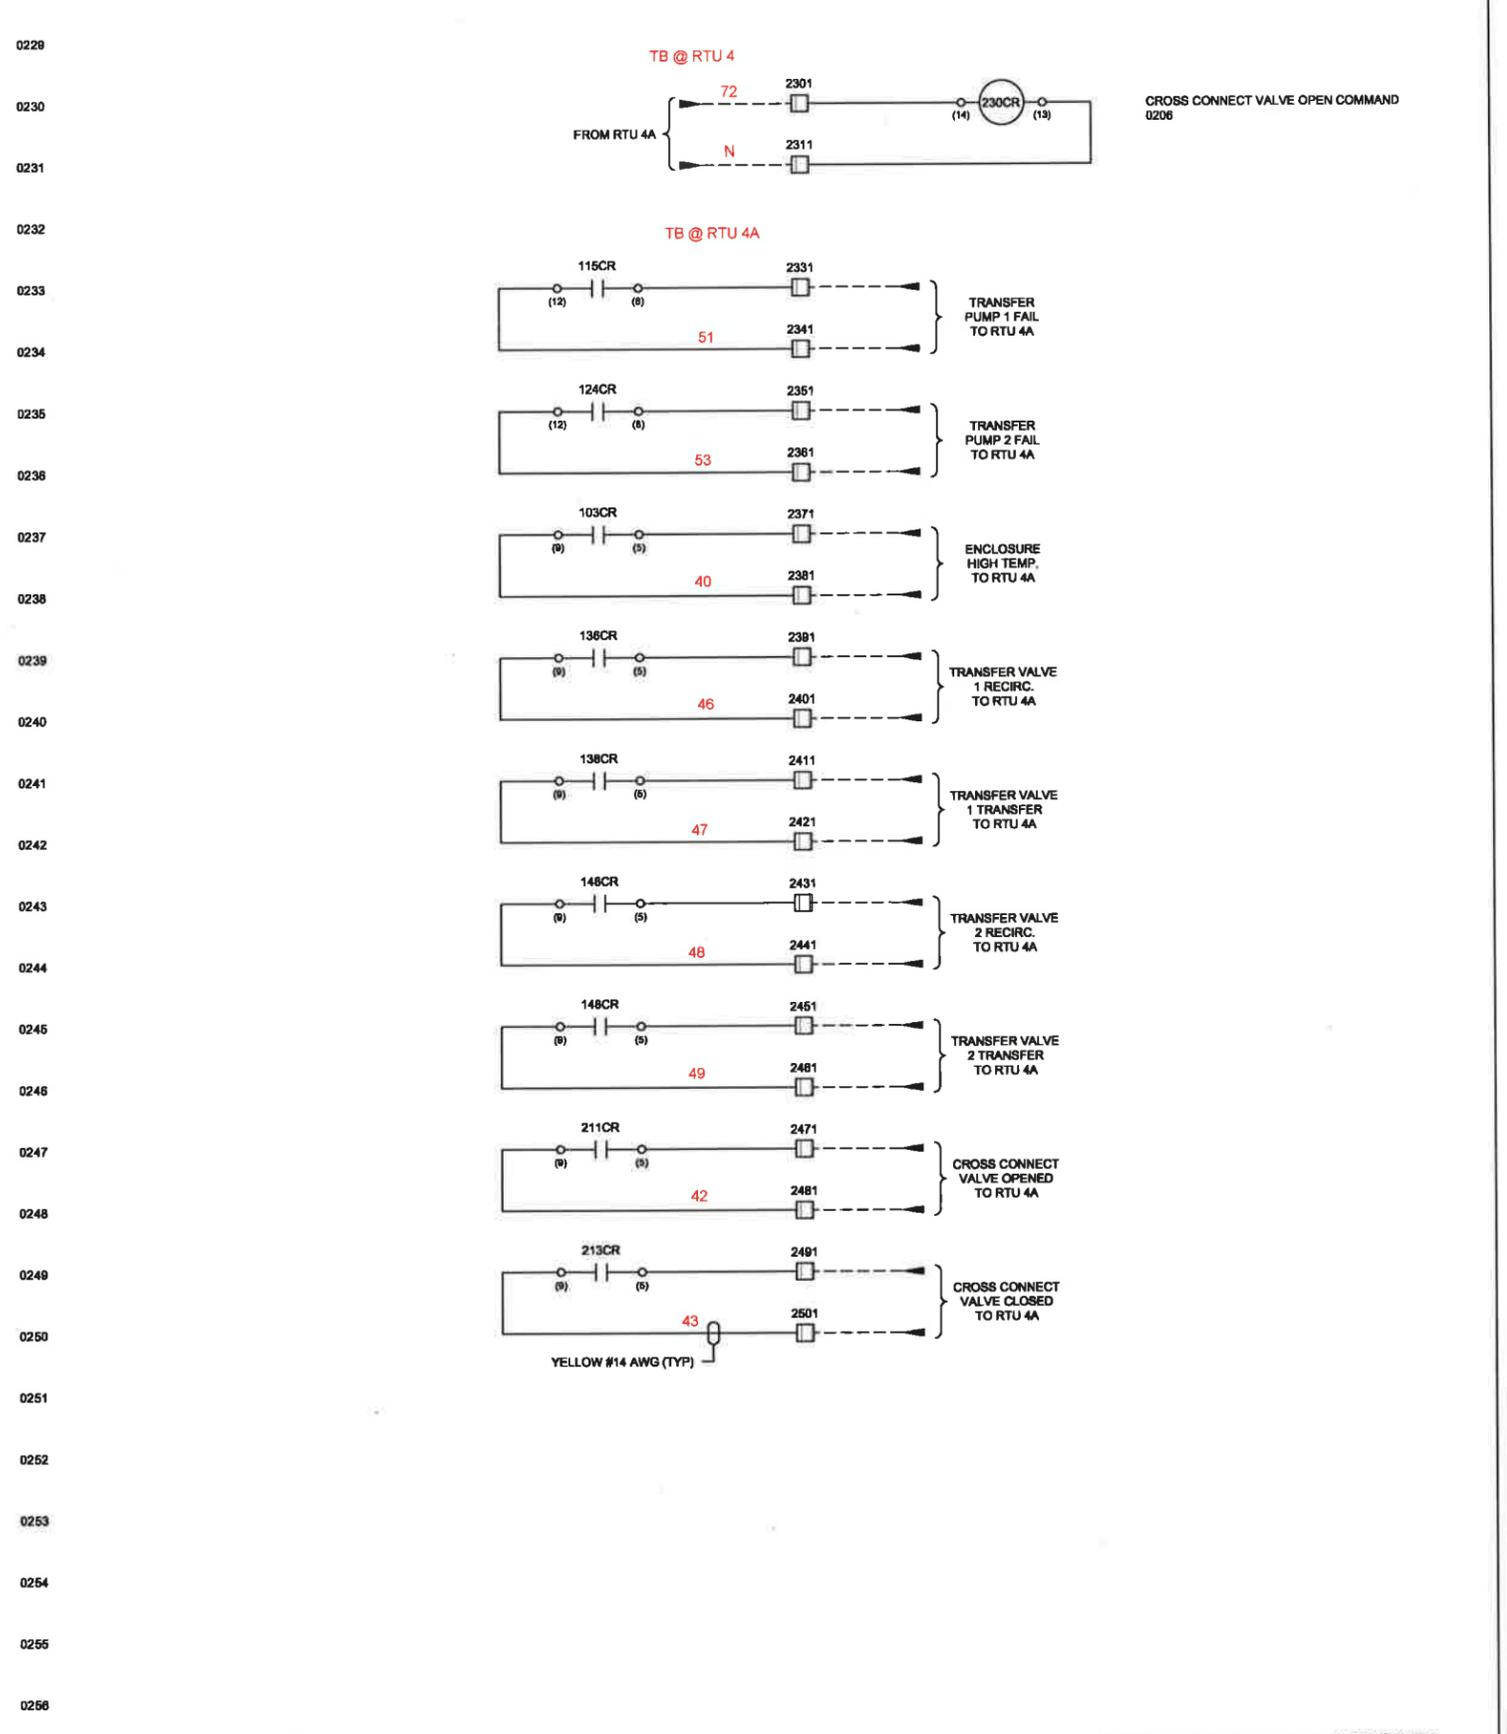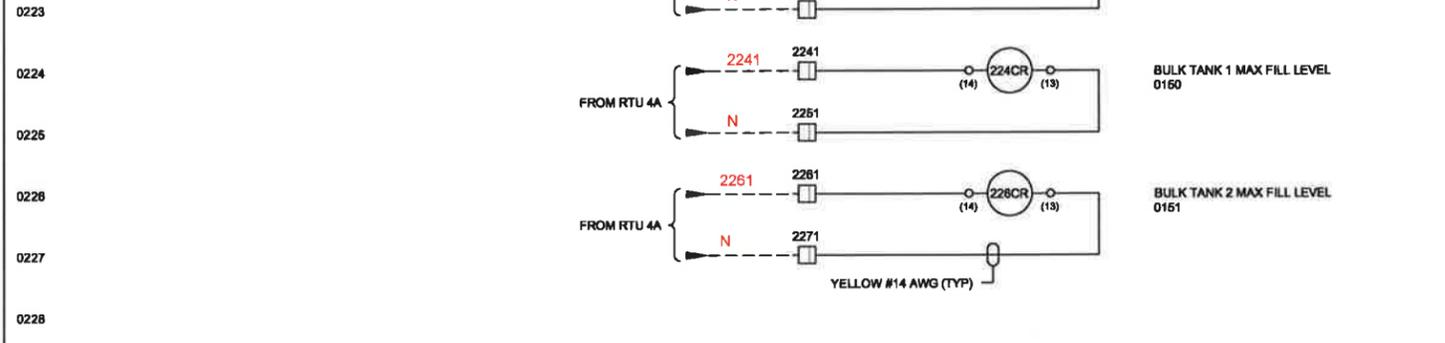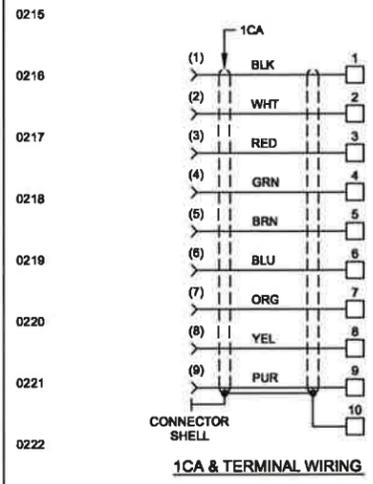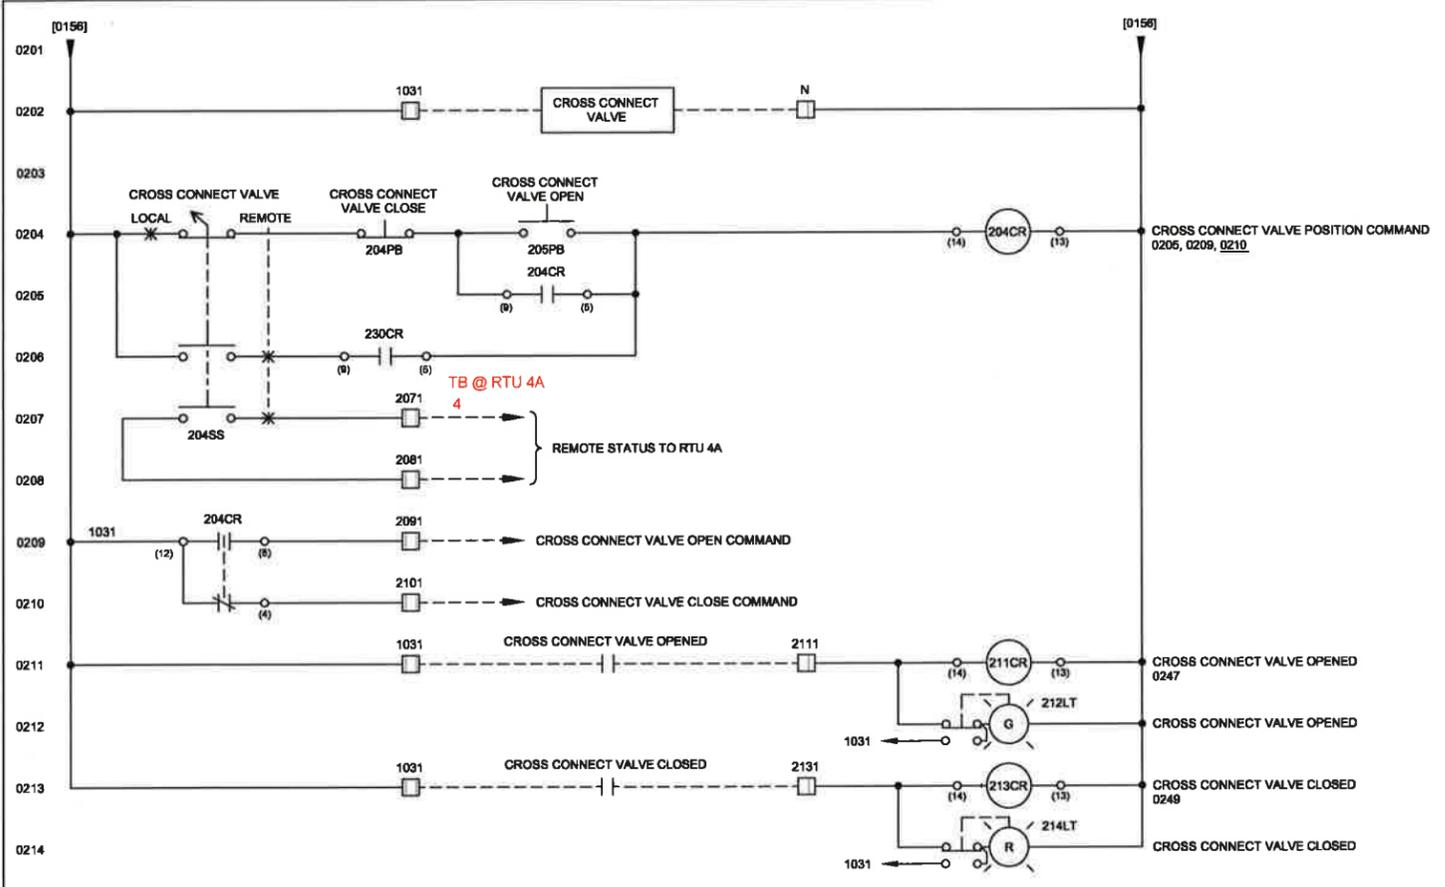

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WESTERN VIRGINIA WATER AUTHORITY  
CARVINS COVE WTF CHEMICAL BUILDING 2  
SODIUM HYPOCHLORITE CONTROL PANEL  
CONTROL WIRING

BY	DATE	SCALE	SIZE	DWG. NO.	SHEET	REVISION
ADH	10/8/14	N/A	D	P14-212B	2 of 2	A

Item	QTY	Symbol	Description	Mfg. & Part Number
1	1		Enclosure, 30 X 30 X 12, SS, NEMA 4X	Saginaw #SCE-30EL3012SS6LP
2	1		Sub-Panel	Saginaw #SCE-30P30
3	1		Dead Front Panel	Saginaw #SCE-DF30EL30LP
4	1		Mounting Foot Kit	Saginaw #SCE-ELMFK4SS
5	1	109HMI	PanelView Plus 6 700	Allen-Bradley #2711P-T7C4A8
6	1	107SPD	Surge Suppressor	Edco #HSP121BT-1RU
7	3	137LT, 147LT, 214LT	Pilot Light, Red LED, Push-to Test	Allen-Bradley #800H-QRTH10R
8	5	117LT, 126LT, 139LT, 149LT, 212LT	Pilot Light, Green LED, Push-to Test	Allen-Bradley #800H-QRTH10G
9	4	118LT, 127LT, 150LT, 151LT	Pilot Light, Amber LED, Push-to Test	Allen-Bradley #800H-QRTH10A
10	5	111PB, 120PB, 133PB, 143PB, 205PB	Pushbutton, Green Flush Head	Allen-Bradley #800H-AR1A
11	5	110PB, 119PB, 132PB, 142PB, 204PB	Pushbutton, Red Flush Head	Allen-Bradley #800H-AR6A
12	1	204SS	Selector Switch,2-Position	Allen-Bradley #800H-HR2B
13	23		Legend Plate, NEMA 4X (engraved as shown)	Allen-Bradley #800H-W500J
14	1	104TAS	Thermostat	Saginaw #SCE-TEMNO
15	1	1CB	Circuit Breaker, 15 AMP	AutomationDirect #WMZT1C15
16	21	All CR's	Relay, 2PDT	Idec #RH2B-ULCAC110-120V
17	21	(for above)	Relay Socket	Idec #SH2B-05
18	116		Terminal Block	Allen-Bradley #1492-J4
19	4		Terminal Block End Barrier	Allen-Bradley #1492-EBJ3
20	11		Terminal Block End Anchor	Allen-Bradley #1492-ERL35
21	2		Terminal Block, Grounding	Allen-Bradley #1492-JG4
22	A/R		DIN Rail, 35mm	Allen-Bradley #199-DR1
23	A/R		DIN Rail, 35mm, Raised	AutomationDirect #DN-R35SAL2-2
24	1		Ground Lug	Blackburn #L35 (or equal)
25	A/R		Wireway with Cover, 1" X 3"	Panduit (or equal)
26	1	1FAN	Fan Heater with Thermostat, 200 Watt	Saginaw #SCE-HF2001A
27	1	2CB	Circuit Breaker, 3 AMP	AutomationDirect #WMZT1C03
28	A/R	1CA	Shielded Cable, #24 AWG, 9-Conductor	Belden #9934 (or equal)
29	1		Connector, DB-9, Female	Purchase
30				

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	BY	DATE
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CHECKED	--	--
APP	--	--
JOB NO.	P14-2129	
REF.		
SCALE	N/A	

WESTERN VIRGINIA WATER AUTHORITY  
CARVINS COVE WTF CHEMICAL BUILDING 2  
SODIUM HYPOCHLORITE CONTROL PANEL  
MATERIALS LIST

SIZE	D	DWG. NO.	175-14-200	SHEET	1	of	1	REVISION	A
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