

**ELECTRICAL PLAN**

**ELECTRICAL LEGEND**

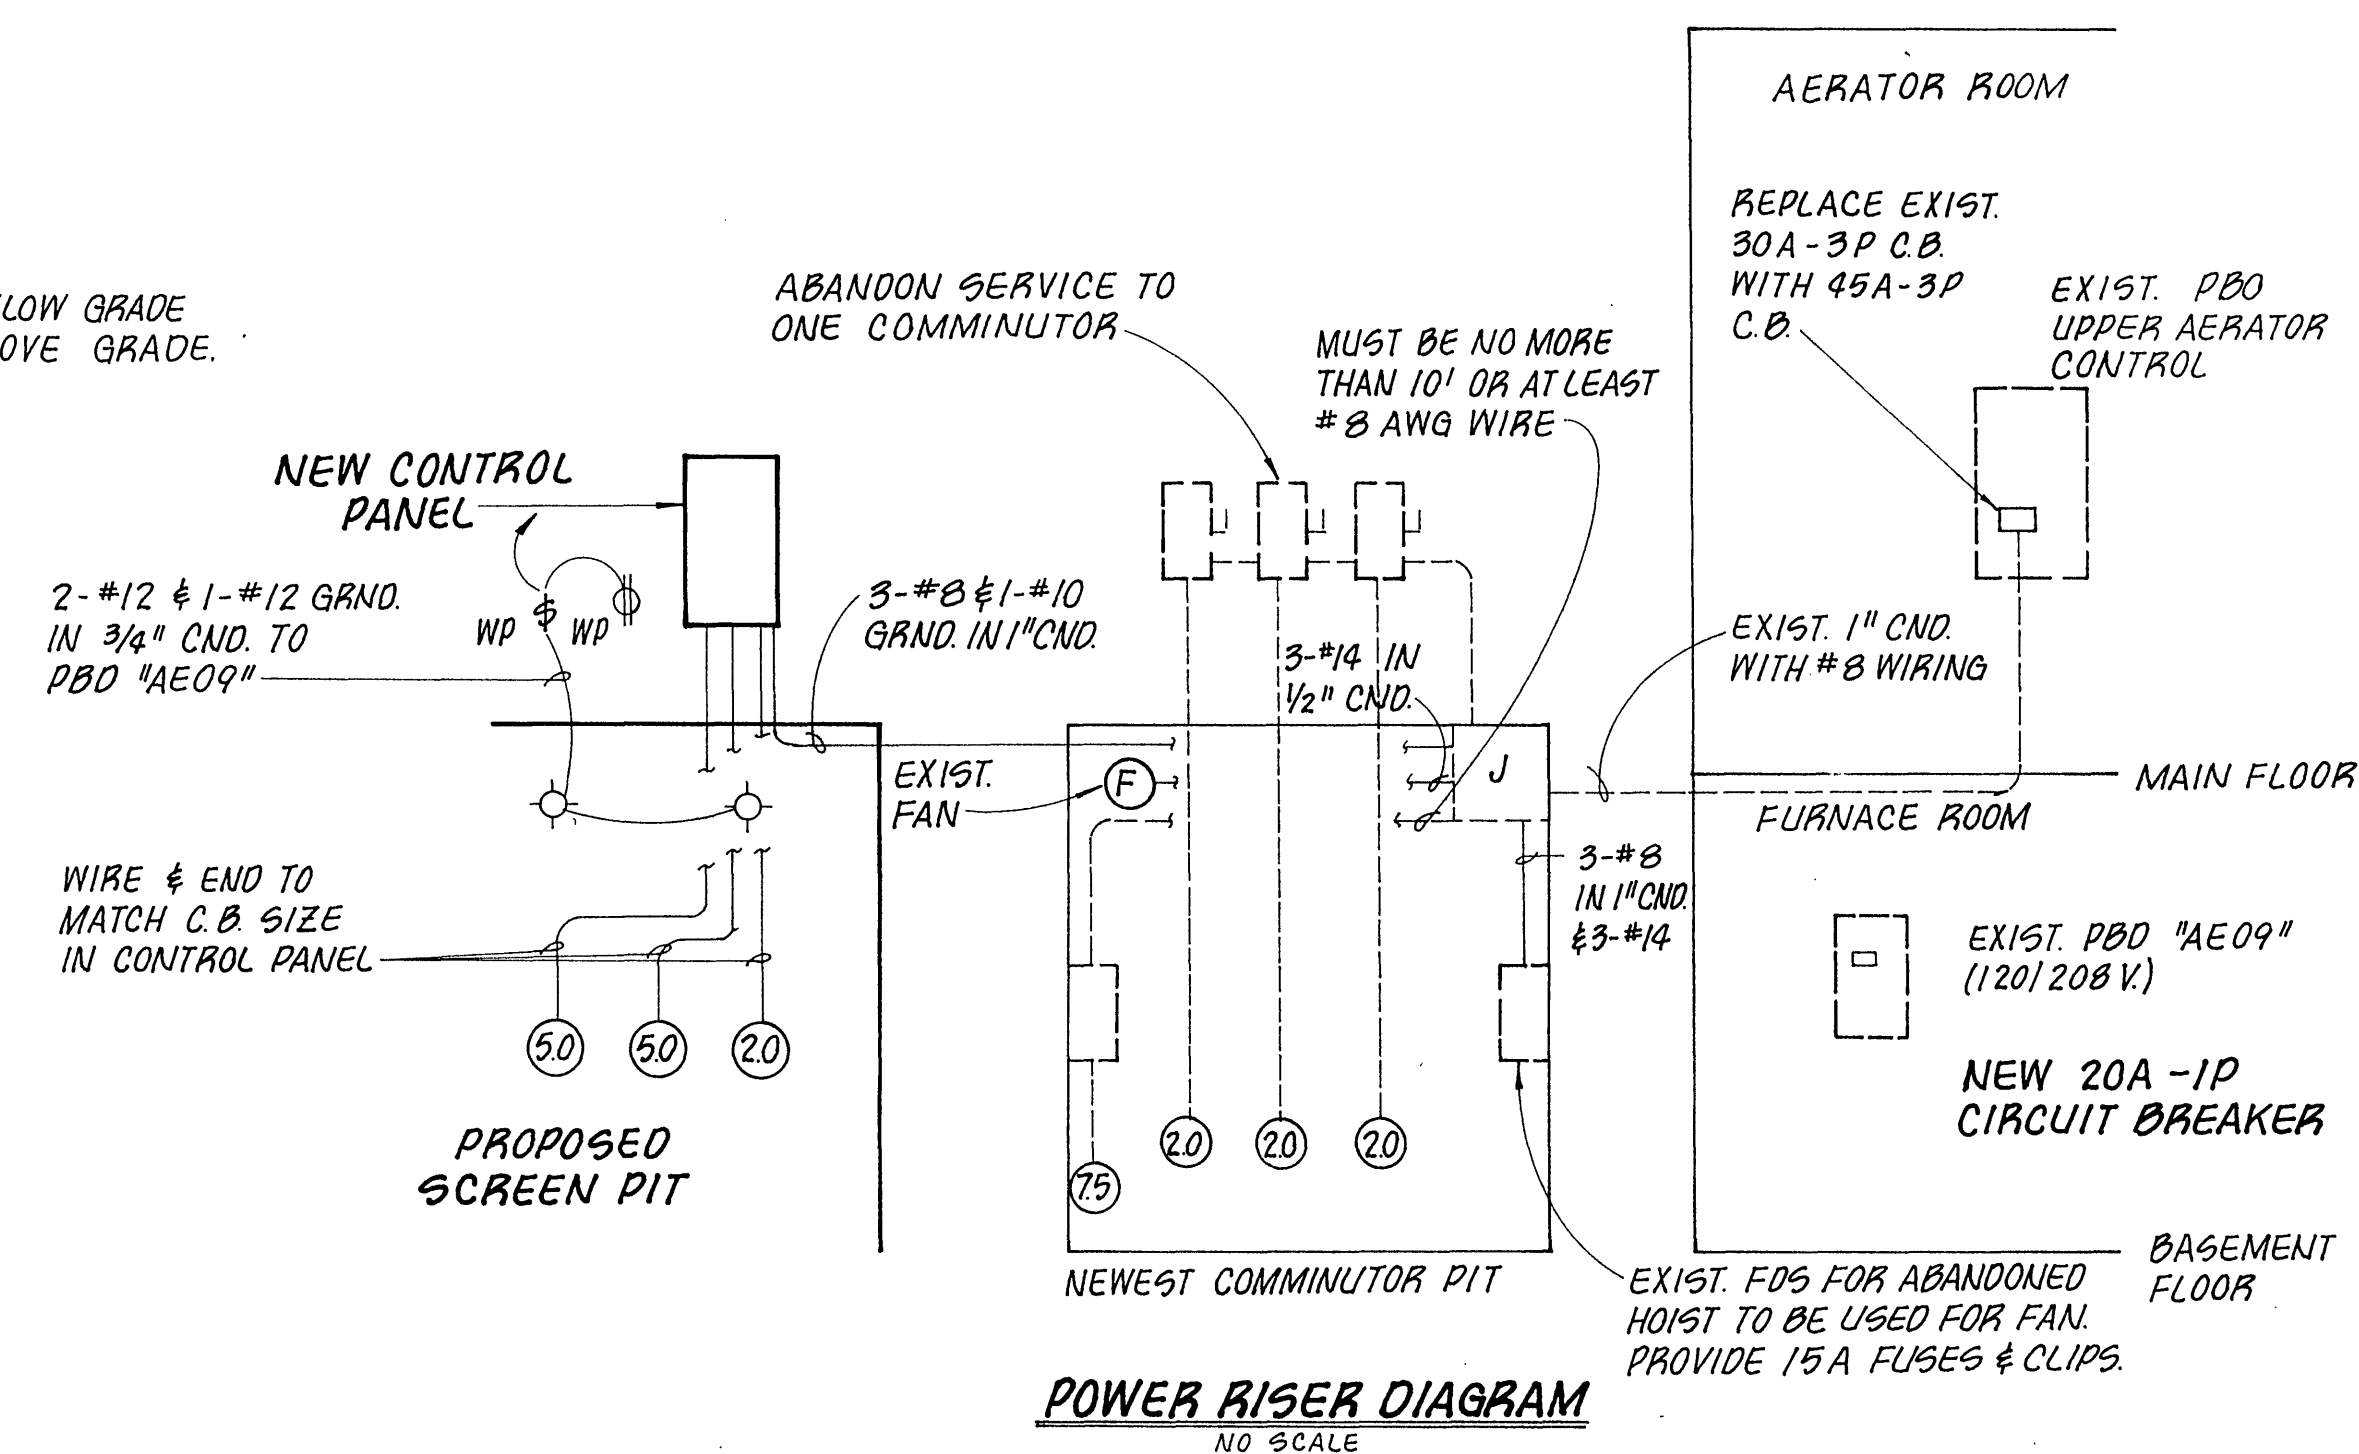
- S SINGLE POLE LIGHT SWITCH
- (J) WIRING JUNCTION BOX OR EQUIPMENT JUNCTION
- N NOTE
- PBD PANELBOARD
- (L) LIGHT FIXTURE—WALL MOUNT
- (M) MOTOR
- (R) REMOTE STATION

**SHEET NOTES**

- N1. Tap 480V service to existing comminutors at wall penetration into main control building. Replace existing 30A breaker for this service with 40A breaker.
- N2. Run conduit underground and beneath slab to screens and conveyor drive motors.
- N3. Light switch and upper level receptacle to be handrail mounted at 908.50. Lower level receptacle to be wall mounted at 892.50.
- N4. 120V/20A service to receptacles and lights shall be run from existing lighting panel located in mechanical room beneath laboratory.
- N5. Lighting fixtures shall be 20A/120V wall mount high pressure sodium as manufactured by General Electric, Model No. H2107L3WGG w/guard, or equal.

**NOTES:**


USE PVC CONDUIT BELOW GRADE  
AND GALV. STEEL ABOVE GRADE.



**MOTOR BRANCH CIRCUIT LOADING**

MOTOR	HP	AMPERAGE
EXIST. COMMUNICATOR	2.0	3.4
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EXIST. PROSSER PUMP	7.5	11.0
EXIST. EXHAUST FAN	FRACT.	1.0
NEW SCREEN DRIVE (4')	1.5	3.2
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NEW CONVEYOR DRIVE	2.0	3.4
<b>TOTAL AMPS</b>		<b>28.6</b>

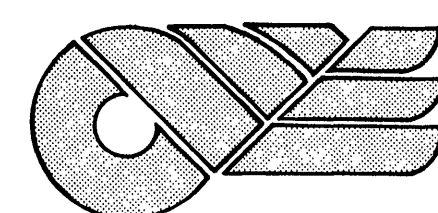CONDUCTOR SIZING: NEC SECT. 430-24 (28.6A + 25%(11.0)) = 31.4 A.




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**HEADWORKS IMPROVEMENTS**  
FOR  
**ROANOKE CITY**  
**WASTEWATER TREATMENT FACILITY**  
**ROANOKE, VIRGINIA**



REVISIONS		
NO.	DATE	BY

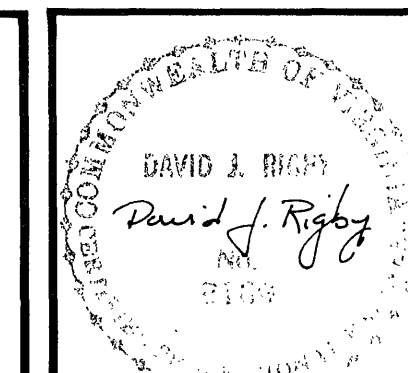DESIGNED: CES	SHEET: 8 OF 8
DRAWN: CCB/TAM	SCALE: AS SHOWN
CHECKED: CES	DATE: NOV., 1987
APPROVED: DJR	PROJECT: F87025